SAGINAW & FORT WORTH, TEXAS



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TECHNOLOGY

1255 Corporate Dr, #100 Irving, Texas 75038 Main Phone: 972.887.5555 www.moyeconsulting.com

100% CONSTRUCTION DOCUMENTS



PROJECT NO.

1821.00

COVER

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NO. OR # NUMBER

OPNG.

P.T.

PROJ.

RAD.

RM.

SHT.

S.C.

SQ.

STD.

T.W.

TERR.

THK.

VERT.

VEST.

WSCT.

W/0

WDW.

WD.

STL. STEEL STOR. STORAGE

STRUC. STRUCTURE

SUSP. SUSPENDED

OFFICE

PAIR

P. LAM. PLASTIC LAMINATE

PLATE

POINT

RADIUS

RISER

R00M

SHEET

SPEC. SPECIFICATION

SIMILAR

SOLID CORE

SQUARE

STANDARD

TACKBOARD

TELEPHONE

TERRAZZO THICK

TREAD

T.O.J. TOP OF JOIST

T.O.S. TOP OF STEEL

T.O.W. TOP OF WALL

TOP OF CURB OR TEACHERS CABINET

UNDERWRITERS LABORATORIES

U.N.O. UNLESS NOTED OTHERWISE

VERTICAL

VESTIBULE

WAINSCOT

WIDE

WITH

WITHOUT

WINDOW

WOOD

WATER CLOSET

V.C.T. VINYL COMPOSITION TILE

VINYL WALL COVERING

TACK WALL

STAINLESS STEEL

ROOF DRAIN or ROUGH DIMENSION

REINF. REINFORCED

REQ'D. REQUIRED

SCHED. SCHEDULE

SECT. SECTION

REFERENCE

PROJECTOR

QUARRY TILE

PLAS. PLASTER

PLYWD. PLYWOOD

ON CENTER

OUTSIDE DIAMETER

OPPOSITE HAND

PARTITION TYPE

ABBREVIATIONS

ARCHITECTURAL

BOARD BOTTOM

CENTER

CENTER LINE

CONTINUOUS

CORRIDOR

DRAWING

DOOR OPENING

ELECTRIC WATER COOLER

ELEVATION OR ELEVATOR

DOWNSPOUT

EXPANSION

FEET or FOOT

FINISH FLOOR LINE

FIRE EXTINGUISHER

FIRE HOSE CABINET

FLOOR DRAIN

FLUORESCENT

GALVANIZED

GENERAL CONTRACTOR

GAUGE

GROUND

HANDICAPPED

HIGH POINT

HORIZONTAL

H.B. / HB HORIZONTAL BLINDS

H0UR

HOLLOW METAL

INSIDE DIAMETER

INSULATION

INTERIOR

JANITOR

JOINT

JOIST

LIGHT

LONG

LOW POINT

LONG LEG HORIZONTAL

LONG LEG VERTICAL

KITCHEN

FIRE EXTINGUISHER CABINET

FLAT HEAD COUNTERSUNK

EXPANSION JOINT

EACH

DTL./DET. DETAIL

DBL.

FIN.

F.D.

GALV.

GYP.

HR.

INSUL.

JST.

KIT.

LAM.

L.P.

COUNTERSUNK

CONTROL JOINT

CTR.

AMERICANS WITH DISABILITIES ACT

SECURITY IMPROVEMENTS AT 8 CAMPUSES

EAGLE MOUNTAIN - SAGINAW I.S.D.

COVER COVER

SAGINAW & FORT WORTH, TEXAS

		MATI	MATERIAL INDICATIONS			
M			EARTH		CERAMIC TILE	
MFR.	MANUFACTURER		POROUS FILL		GLASS (LARGE SCALE)	
M.B. M.O.	MARKER BOARD MASONRY OPENING		CONCRETE		INSULATION (RIGID)	
MAS.	MASONRY		BRICK		INSULATION (BATT)	
MAX. MECH.	MAXIMUM MECHANICAL		CMU		INSULATION (RIGID)	
MET./MTL.	METAL		MARBLE METAL (LARGE SCALE)		WOOD, ROUGH (CONT.) WOOD, ROUGH (BLOCKING	
MIN. MISC.	MINIMUM MISCELLANEOUS		METAL (SMALL SCALE)		WOOD, FINISH	
MULL.	MULLION		RESILIENT FLOORING		PLYWOOD (LARGE SCALE	
N		[ACOUSTICAL TILE		STUD WALL	
NOM.	NOMINAL		TERRAZZO	1111	METAL LATH	
N.I.C. N.T.S.	NOT IN CONTRACT NOT TO SCALE		PLASTER, SAND, GROUT	<i>2432</i> 6	GYPSUM BOARD	

BUILDING DESIGN CRITERIA

SECURITY IMPROVEMENTS AT 8 CAMPUSES

INTERNATIONAL BUILDING CODE W/

INTERNATIONAL PLUMBING CODE W/

INTERNATIONAL MECHANICAL CODE W/

FORT WORTH AMENDMENTS

FORT WORTH AMENDMENTS

FORT WORTH AMENDMENTS

FORT WORTH AMENDMENTS

NATIONAL ELECTRIC CODE W/

FORT WORTH AMENDMENTS

TEXAS ACCESSIBILITY STANDARDS

INTERNATIONAL BUILDING CODE W/

INTERNATIONAL PLUMBING CODE W/

INTERNATIONAL MECHANICAL CODE W/

INTERNATIONAL FIRE CODE W/

SAGINAW AMENDMENTS

SAGINAW AMENDMENTS

SAGINAW AMENDMENTS

SAGINAW AMENDMENTS

SAGINAW AMENDMENTS

NATIONAL ELECTRIC CODE W/

TEXAS ACCESSIBILITY STANDARDS

INTERNATIONAL FIRE CODE W/

PROJECT IDENTIFICATION

EAGLE MOUNTAIN - SAGINAW I.S.D.

II. APPLICABLE CODES

2015

2015

2012

2012

2012

2012

2012

2011

8 PROJECT LOCATIONS LISTED BELOW

CLASSROOM A201	ROOM NUMBER MARK	<u>1</u>	LOUVER MARK
A203	DOOR NUMBER MARK	8	NUMBERED NOTE MARK
A	STOREFRONT MARK	\bigoplus^{N}	NORTH ARROW
P1	PARTITION TYPE MARK	HB	HORIZONTAL BLINDS
DWG. NO. A4.Q1 SHEET NO.	SECTION MARK	DWG. NO:- 3/A8.01	ELEVATION MARK
<u>(G.O.</u>)	GLAZED OPENING MARK	DWG. NO. 6/A4.05 SHEET NO	SECTION DETAIL MARK
•	DATUM ELEVATION MARK	AC	ACCESS CONTROL MARK

SYMBOLS / LEGEND

PT	PARTITION TYPE WARK	(HB)	HUKIZUNI	IAL BLINDS
DWG. NO. A4.01 SHEET NO.	SECTION MARK	DWG. NO. 3/A8.01 SHEET	ELEVATION	N MARK
<u>G.O.</u>	GLAZED OPENING MARK	DWG. NO. 6/A4.05 SHEET		DETAIL MARK
•	DATUM ELEVATION MARK	△ AC →	ACCESS (CONTROL MARK
TEXAS	ACCESSIBILITY S	STANDARE	DS .	
PROVISIONS F	OR ADULTS AND CHILDREN	ADU AGES 13		CHILDREN AGES 12 & UNDE
REACH RANGES		400.4444	(5) MM	
FRONTAL OR	SIDE APPROACH	48" MAX	- 15" MIN.	16" MIN 44" MAX.
RAMPS AND STAI	RS (HANDRAILS)			
	DRAIL GRIPPING SURFACE	34" -	38"	34" - 38"
	AINS AND WATER COOLERS			
FRONTAL APF		2611 N	1 A V	LICE CIDE ADDDOAC
KNEE CLE	EIGHT (TO OUTLET) FARANCE	36" N 27" N		USE SIDE APPROAC
SIDE APPROA		2	VIII V.	
SPOUT HI	EIGHT (TO OUTLET)	USE FRONT	APPROACH	30" MAX.
KNEE CLE	EARANCE			NOT REQUIRED
WATER CLOSETS				
CENTERLINE T	TO WALL AT WHEELCHAIR ACCESS	SIBLE 16" -	18"	12" - 18"
CENTERLINE	TO WALL AT AMBULATORY STALL	17" -	19"	17" - 19"
TOP OF SEAT		17" -		11" - 17"
GRAB BARS		33" -		18" - 27"
	IEIGHT (MOUNT AT 7"-9" FROM	15" -	48"	14" - 19"
	INE OF DISPENSER IN FRONT OF W	•	4.4.V	
FLUSH CONTI	KUL9	36" N	ЛАХ.	36" MAX.
URINALS				
RIM OF BASIN	J	17" \	ΛΛΥ	16" MAY *

NIVEE OLEANAINOE	ZI IVIIIN.	
SIDE APPROACH	LICE EDONT ADDDOAGL	
SPOUT HEIGHT (TO OUTLET) KNEE CLEARANCE	USE FRONT APPROACH	30" MAX. NOT REQUIRI
NNEE GELANANGE		NUI NEQUINI
WATER CLOSETS		
CENTERLINE TO WALL AT WHEELCHAIR ACCESSIBLE	16" - 18"	12" - 18"
CENTERLINE TO WALL AT AMBULATORY STALL	17" - 19"	17" - 19"
TOP OF SEAT	17" - 19"	11" - 17"
GRAB BARS	33" - 36"	18" - 27"
DISPENSER HEIGHT (MOUNT AT 7"-9" FROM	15" - 48"	14" - 19"
CENTERLINE OF DISPENSER IN FRONT OF W.C.)		
FLUSH CONTROLS	36" MAX.	36" MAX.
LIDIMAL C		
URINALS PIA OF DACIN	4711 1 1 1 1 1 1	4 C 1 M A V / *
RIM OF BASIN	17" MAX.	16" MAX.*
FLUSH CONTROLS	48" MAX.	44" MAX.
LAVATORIES AND SINKS		
RIM OR COUNTER SURFACE	34" MAX.	31" MAX.
KNEE CLEARANCE (LAVATORIES)	27" MIN.	24" MIN.
KNEE CLEARANCE (SINKS)	27" MIN.	24" MIN.
TO FAUCETS FROM FRONT EDGE	20" MAX.*	18" MAX.*
MIDDODC		
MIRRORS TO TOP OF REFLECTIVE SURFACE	74" MIN.	74" MIN.
TO BOTTOM OF REFLECTED SURFACE AT SINKS & LAV		35" MAX.*
TO BOTTOM OF NEFLECTED SURFACE	35" MAX.	35" MAX.*
CONTROLS AND OPERATING MECHANISM		
HIGHEST OPERABLE PART		
FRONTAL AND SIDE APPROACH	48" MAX.	44" MAX.
TELEPHONES		
HIGHEST OPERABLE PART		
FRONTAL AND SIDE APPROACH	48" MAX.	44" MAX.
FIVED OD DIJLIT IN CEATING TADI EC. 0 MODIZ CTATIONO		
FIXED OR BUILT-IN SEATING, TABLES, & WORK STATIONS HEIGHT OF TABLES OR COUNTERS	26" - 30"	26" - 30"
KNEE CLEARANCES	24" MIN.	24" MIN.
DRESSING & FITTING ROOMS		
TOP OF BENCH (20"-24"D X 42"L MIN)	17" - 19"	11" - 17" *
BACK SUPPORT 18"H MIN. OR MOUNT TO WALL		
FOOD SERVICE LINES		
TOP OF TRAY SLIDE	28" - 34"	32" *
* NOTE DIMENSION FOR OPENIES AGE OROUGH IS NOT LIS	TED IN 0040 TAC	
* NOTE: DIMENSION FOR SPECIFIC AGE GROUP IS NOT LIS	TED IN 2012 TAS	

INDEX TO DRAWINGS

	ARCHITECTURAL
A1.01	ORIENTATION PLAN - LEVEL ONE
A1.02	ORIENTATION PLAN - LEVEL ONE
A2.01	FLOOR PLAN & ELEVATIONS - HIGH COUNTRY
A2.02	FLOOR PLAN & ELEVATIONS - REMINGTON POINT
A2.03	FLOOR PLAN & ELEVATIONS - CHISOLM RIDGE
A2.04	FLOOR PLAN & ELEVATIONS - GREENFIELD
A2.05	FLOOR PLAN & ELEVATIONS - COMANCHE SPRINGS
A2.06	FLOOR PLAN & ELEVATIONS - NORTHBROOK
A2.07	FLOOR PLAN & ELEVATIONS - LAKE POINTE
A2.08	FLOOR PLAN & ELEVATIONS - PARKVIEW
A7.01	DOOR & STOREFRONT DETAILS

INDEX INDEX TO DWGS, DESIGN CRITERIA, GENERAL NOTES

MECHANICAL

ELECTRICAL

TECHNOLOGY

SECURITY

GENERAL NOTES

	BEGINNING CONSTRUCTION. NOTIFY THE ARCHITECT OF CONFLICTS OR VARIATIONS PRIOR
	TO COMMENCEMENT OF CONSTRUCTION.
2.	GYPSUM WALLBOARD SHALL BE TYPE "X" FIRECODE.
3.	PROVIDE LINTELS AS REQUIRED AND DIRECTED OVER OPENINGS IN WALLS WHERE
	MECHANICAL EQUIPMENT PENETRATES WALLS.
4.	AT DRYWALL WALL CONSTRUCTION WHICH EXTENDS ABOVE CEILING, PROVIDE LIGHT GAUGE
	FRAMING AND BRACING AT 4'-0" O.C., TYPICAL, TO STRUCTURE ABOVE IN ORDER TO PROVIDE

5. AT CEILING FURRING DETAILS; SUSPENSIONS, BRACING, BLOCKING, ETC., SHOWN IS

SECURE PERMANENT, AND RIGID ANCHORAGE OF WALLS, TYPICAL.

1. VERIFY AND DOCUMENT EXISTING DIMENSIONS & CONDITIONS AT THE SITE BEFORE

- SCHEMATIC REPRESENTATION ONLY. PROVIDE SECURE PERMANENT ANCHORAGE AT FURRINGS IN ACCORDANCE WITH RECOMMENDED DRYWALL INSTALLATION PRACTICE, 6. BUILD WALLS PLUMB AND TRUE WITH 90 DEGREE CORNERS, UNLESS NOTED OTHERWISE. 7. AT MECHANICAL AND BOILER ROOMS, SEAL PARTITIONS TIGHTLY AROUND STRUCTURAL, MECHANICAL, AND ELECTRICAL PENETRATIONS.
- TO ACCOMMODATE MECH. AND ELEC. FACILITIES. 9. SUBMIT PATTERN OF CONTROL JOINTS IN FACE BRICK, CMU, GYPSUM BOARD TO THE ARCHITECT PRIOR TO CONSTRUCTION. 10. FLOOR PLAN DIMENSIONS ARE TO FACE OF CMU OR STUD UNLESS NOTED OTHERWISE. 11. EXTREME CARE SHALL BE TAKEN TO AVOID DAMAGE TO EXISTING TREES AND SHRUBS,

8. PROVIDE OPENINGS, LINTELS, CURBS, AND FLASHING, THROUGH FLOORS, WALLS AND ROOF

- CONTRACTOR SHALL PROVIDE PROTECTIVE BARRIERS AROUND THOSE IN PROXIMITY TO THE 12. PROVIDE 1" BULLNOSE AT ALL EXPOSED VERTICAL EDGES OF CMU. 13. ALL CMU WALLS SHALL HAVE 8" STARTER COURSES UNLESS NOTED OTHERWISE. 14. SEAL PARTITION TIGHTLY AROUND ALL STRUCTURAL, MECHANICAL, PLUMBING AND
- ELECTRICAL PENETRATIONS WITH SAFING. AT ALL INTERIOR AND EXTERIOR MASONRY CORNERS, PROVIDE A 3/8" BUTT CONTROL JOINT. 16. USE BULLNOSE TILE AT OUTSIDE CORNERS AND TOP OF WAINSCOT AT CERAMIC TILE. 17. PROVIDE SEALANT AND FIRESAFING AT ALL FLOOR PENETRATIONS AND EXPANSION JOINTS. 18. PROVIDE MINIMUM 2"X6" F.R. WOOD BLOCKING BETWEEN METAL STUDS IN NEW PARTITIONS AT MOUNTING LOCATIONS FOR ACCESSORIES, HANDRAIL CASEWORK, MARKER BOARDS, FOLDING PARTITIONS, ETC.
- 19. AT GYPSUM WALLBOARD AND PLASTER WORK USE CORNER BEADS, CASING BEADS AND METAL ACCESSORIES AS REQUIRED TO PROVIDE FINISH SURFACE TERMINATIONS. 20. IN CASE OF DISCREPANCIES IN THE CONSTRUCTION DOCUMENTS, THE GREATER QUANTITY OR QUALITY SHALL BE PROVIDED.
- 21. THE USE OF 3 5/8" CMU FOR INTERIOR PARTITIONS IS NOT PERMITTED EXCEPT FOR USE IN CHASES. FREESTANDING 3 5/8" CMU PARTITIONS ARE NOT ALLOWED.

SITE LOCATIONS

CHISOLM RIDGE ELEMENTARY SCHOOL

HIGH COUNTRY ELEMENTARY SCHOOL 1301 HIGH COUNTRY TRAIL, SAGINAW, TX 76131

REMINGTON POINT ELEMENTARY SCHOOL 6000 OLD DECATUR RD, FORT WORTH, TX 76179

5436 RUNNING RIVER LN, FORT WORTH, TX 76131 GREENFIELD ELEMENTARY SCHOOL

6020 TEN MILE BRIDGE RD, FORT WORTH, TX 76135

COMANCHE SPRINGS ELEMENTARY SCHOOL 4569 COMACHE SPRINGS DR. FORT WORTH, TX 76131

NORTHBROOK ELEMENTARY SCHOOL 2500 CANTRELL SANSOM RD, FORT WORTH, TX 76131

LAKE POINTE ELEMENTARY SCHOOL 5501 PARK DR, FORT WORTH, TX 76179

PARKVIEW ELEMENTARY SCHOOL 6225 CRYSTAL LAKE DR, FORT WORTH, TX 76179

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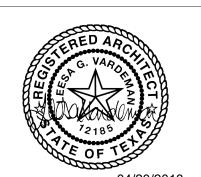
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INDEX TO DRAWINGS **DESIGN CRITERIA GENERAL NOTES**

SHEET NO.

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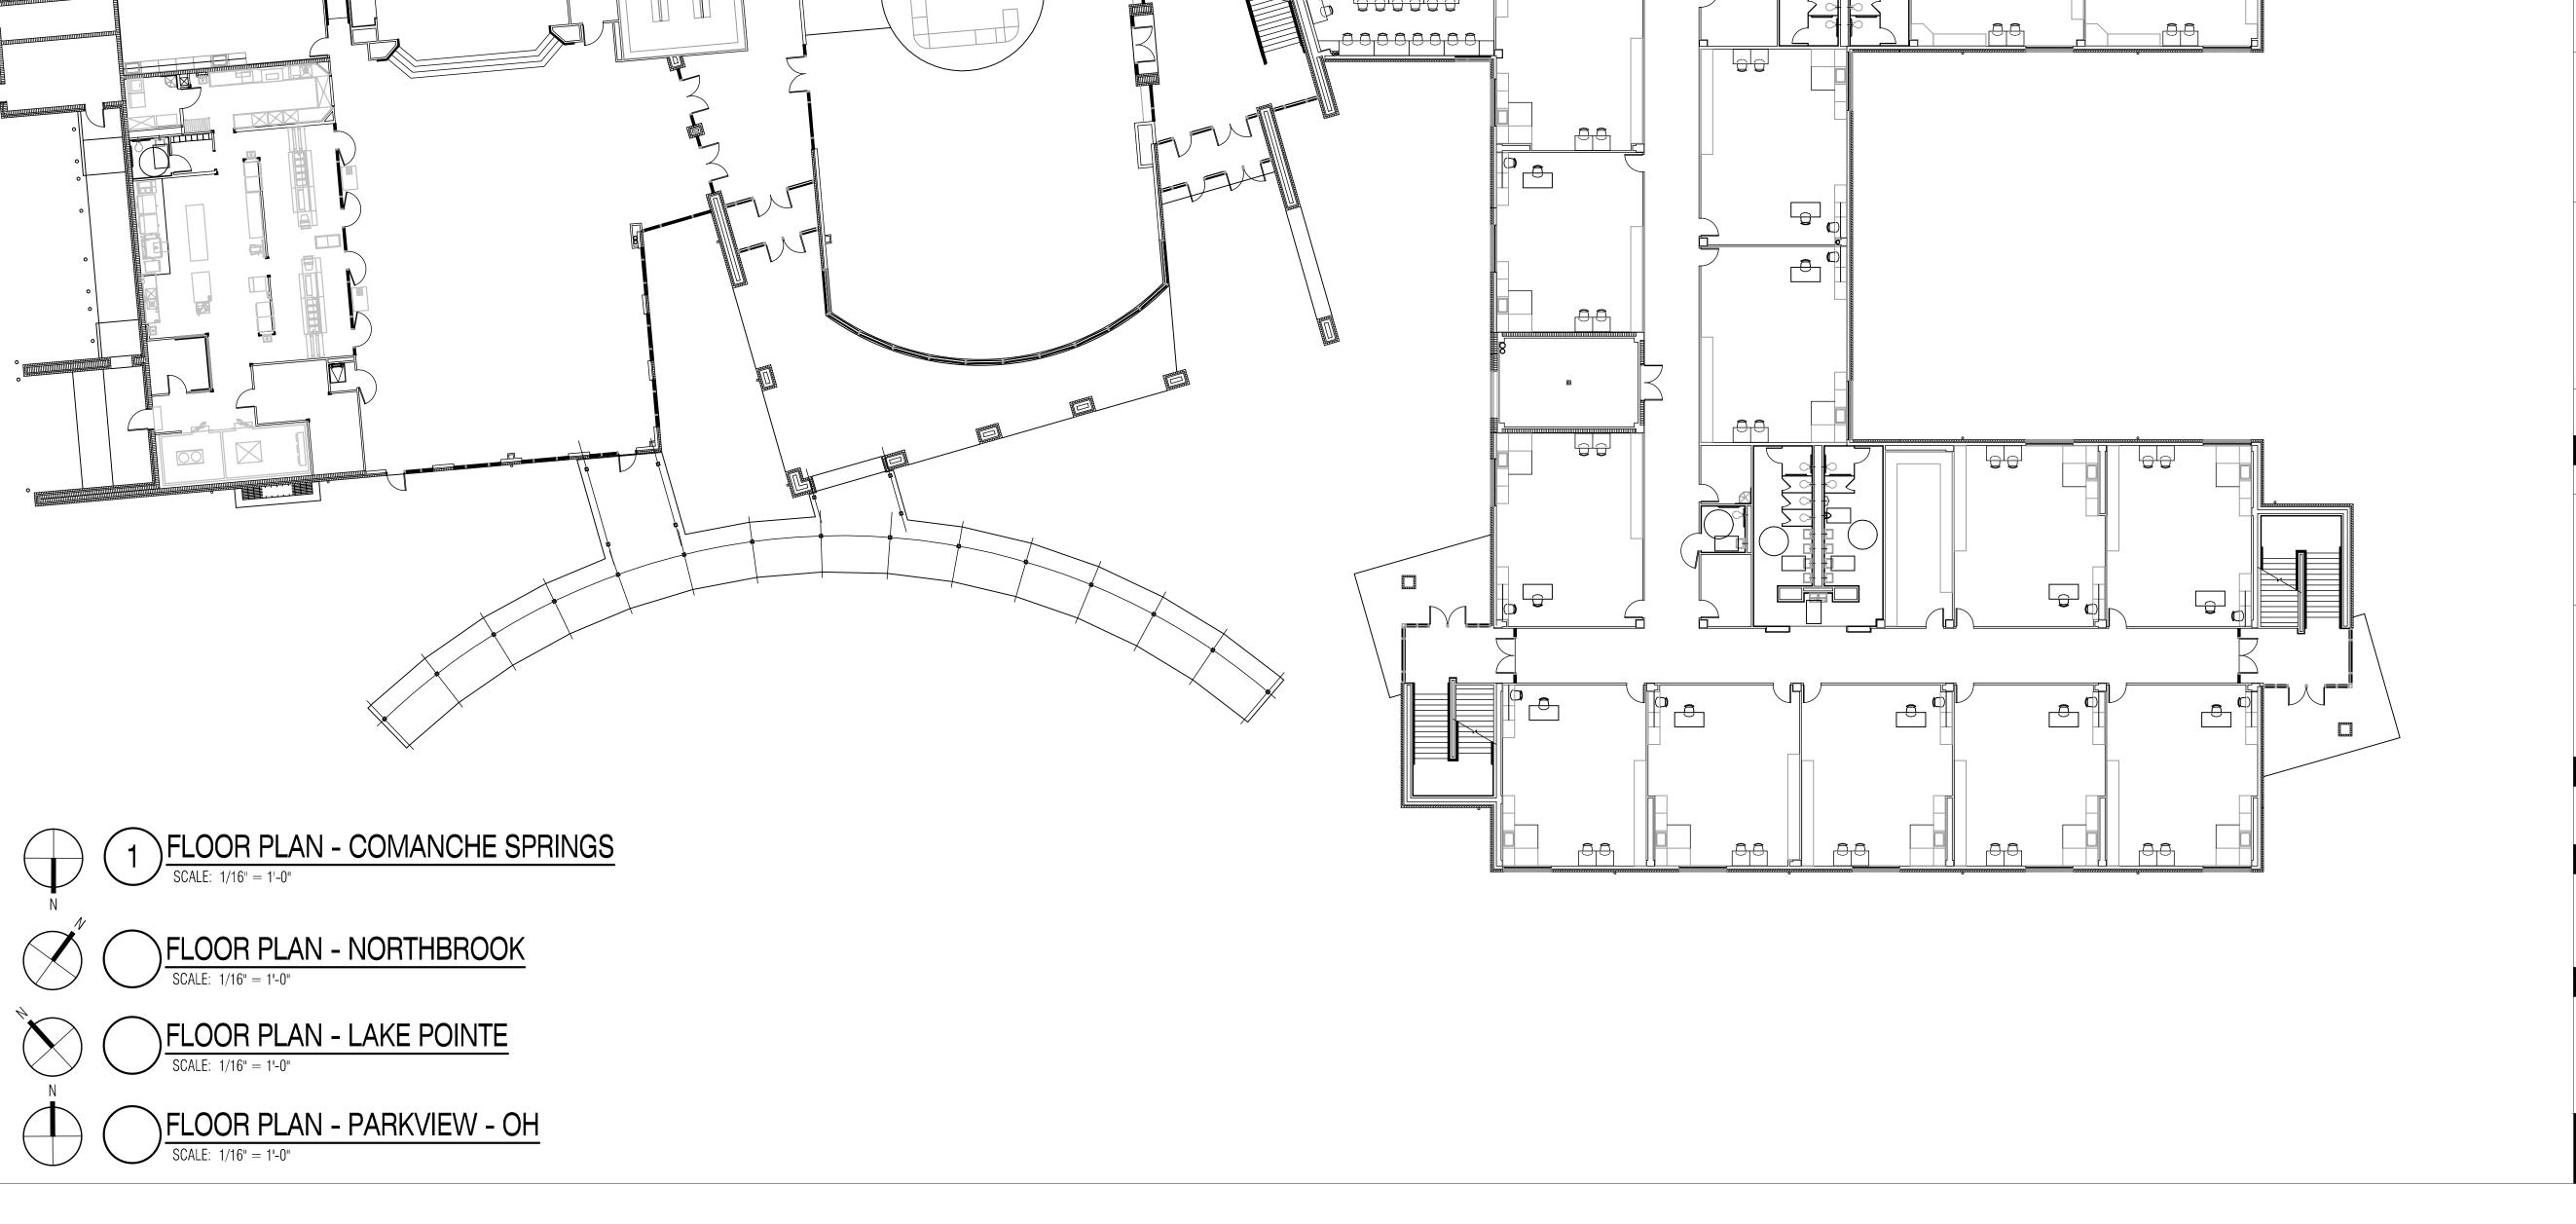
ORIENTATION PLAN LEVEL ONE

SHEET NO.

A1.02

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SECURITY



A2.05-A2.08

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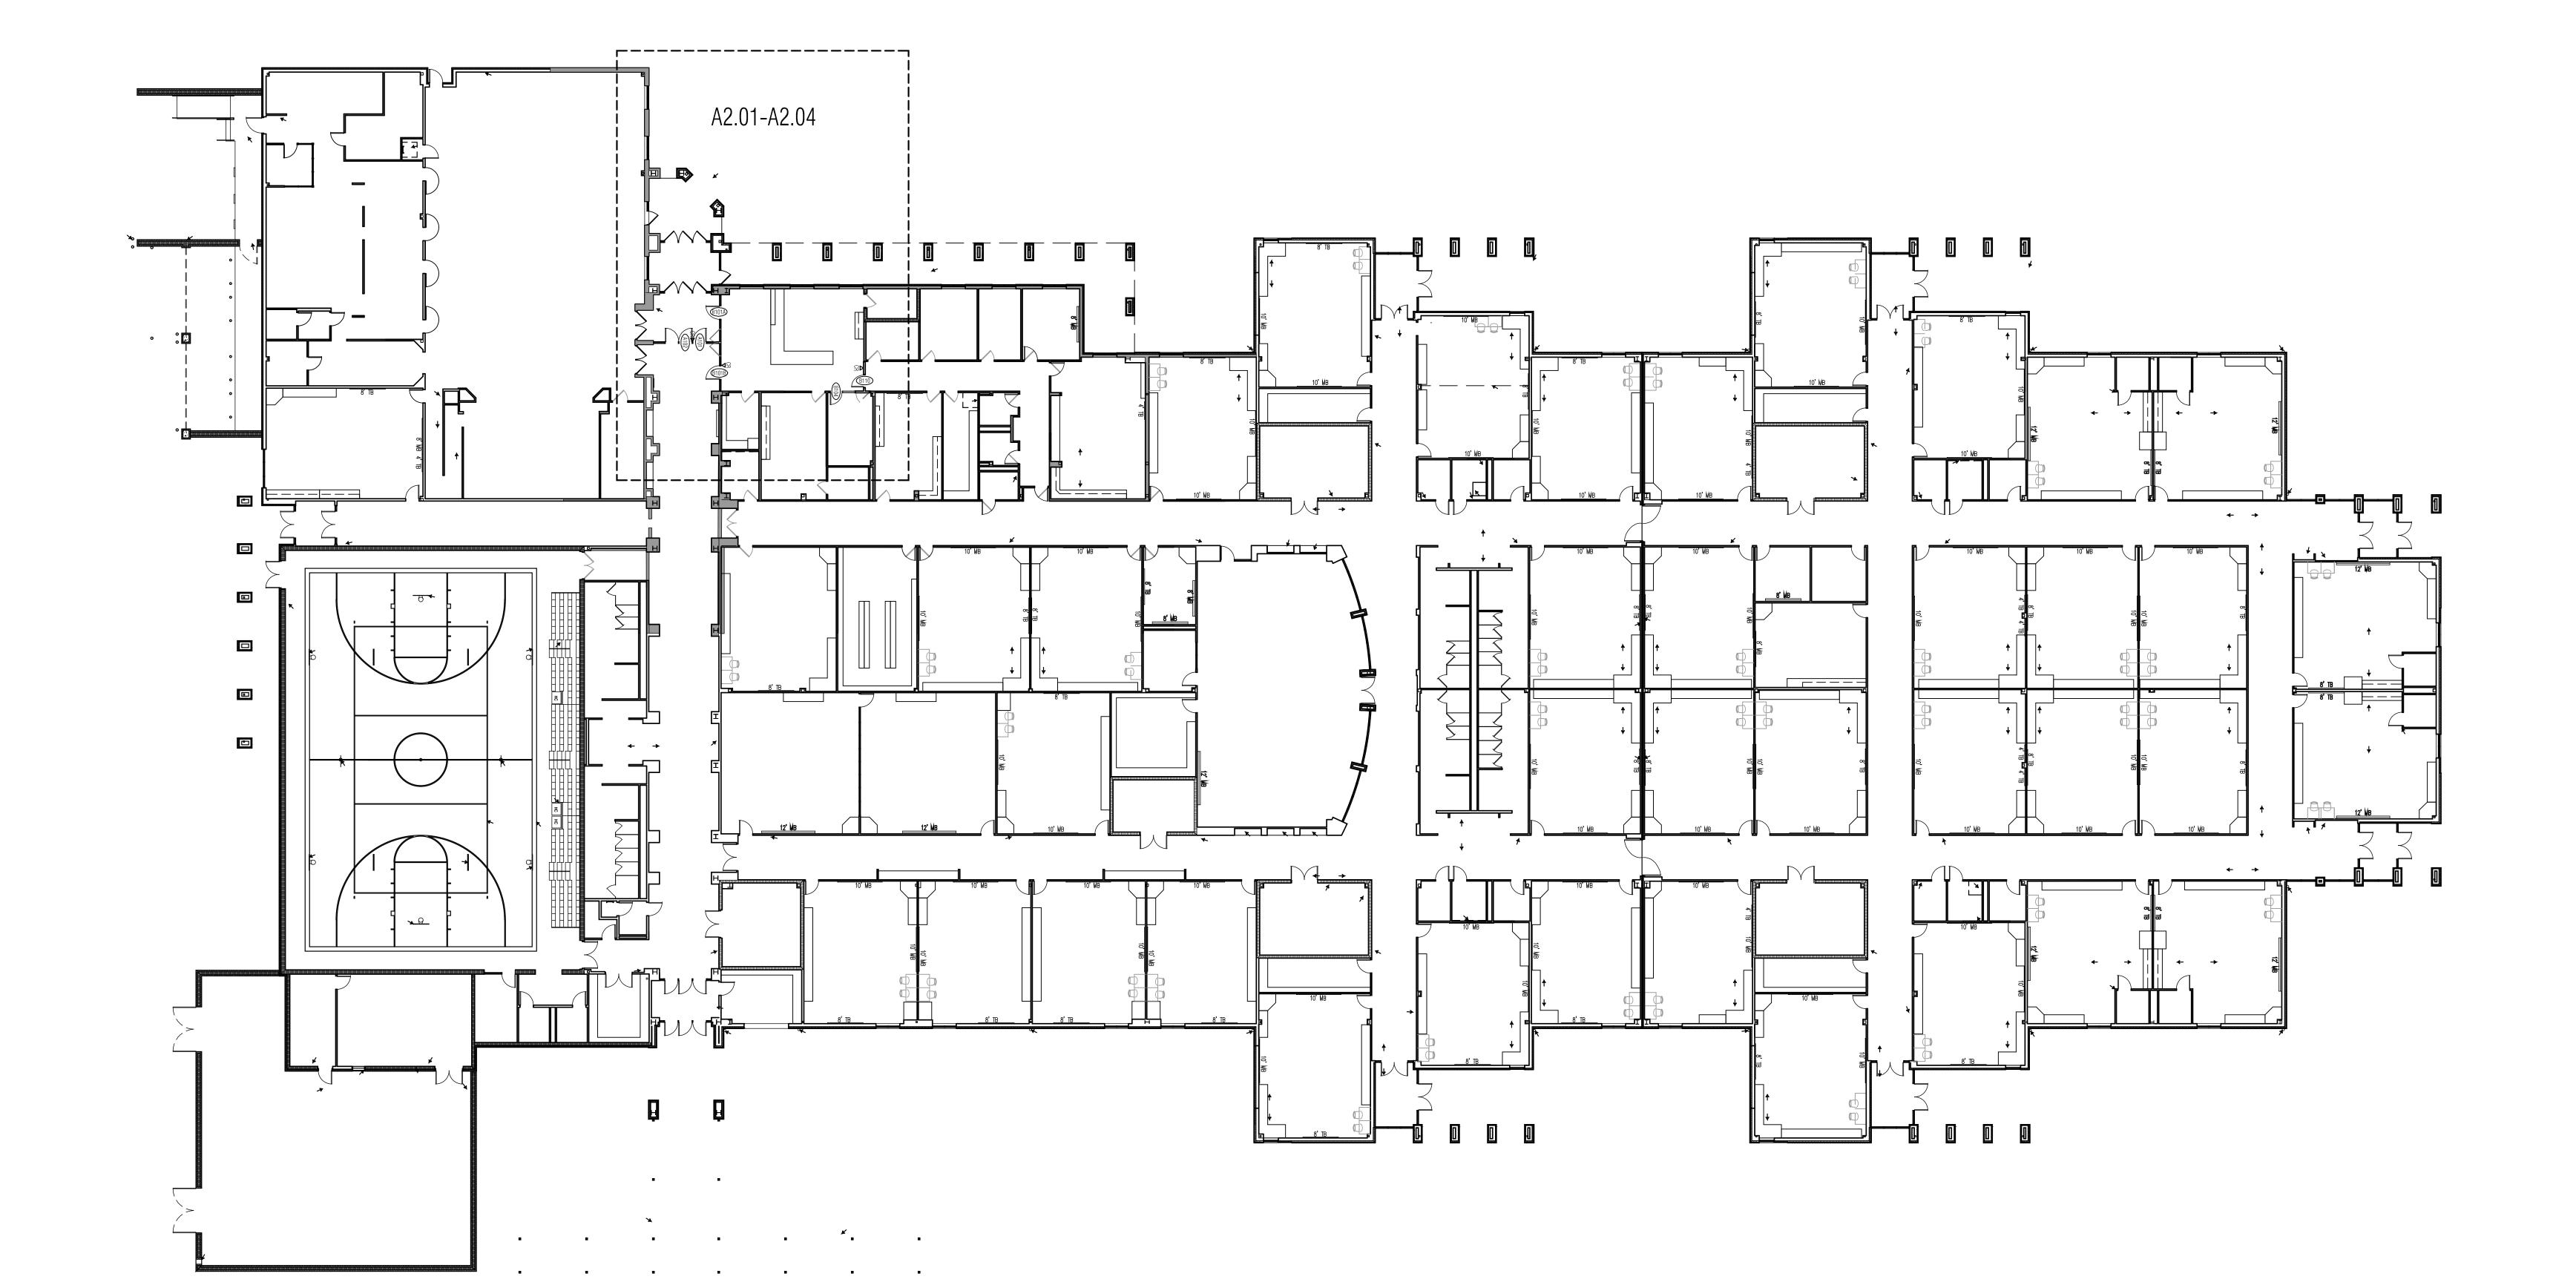
SHEET TITLE ORIENTATION PLAN

LEVEL ONE

SHEET NO.

A1.01

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FLOOR PLAN- HIGH COUNTRY

SCALE: 1/16" = 1'-0"

FLOOR PLAN- REMINGTON POINTE ES

SCALE: 1/16" = 1'-0"

FLOOR PLAN- CHISOLM RIDGE

SCALE: 1/16" = 1'-0"

FLOOR PLAN- GREENFIELD ES

SCALE: 1/16" = 1'-0"

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VLK Architects, Inc.

2821 West 7th Street, Suite 300

GLASS TYPE LEGEND

--- C701A ACCESS CONTROL HARDWARE

--- C701A ACCESS CONTROL HARDWARE

--- C701 ACCESS CONTROL HARDWARE

* HARDWARE TO MEET TDLR REQUIREMENTS

CT TEMPERED INSULATING GLASS 1" THICK, CLEAR CT4 TEMPERED INSULATING GLASS 1/4" THICK, CLEAR

DOOR SCHEDULE

PORTION OF EXISTING GLAZING AND FRAMING

TO REMAIN

1 STOREFRONT ELEVATION

SCALE: 1/4" = 1'-0"

2 STOREFRONT ELEVATION

SCALE: 1/4" = 1'-0"

A102

(A101)

FACE OF EX FURRDOWN

COLD FORMED BOX HEADER.

BRACE TO EXISTING FRAMING
PROVIDE SLIP TRACK
FOR VERTICAL DEFLECTION

REMOVABLE MULLION

3 PARTITION TYPE


SCALE: 1 1/2" = 1'-0"

FINISH, AS SCHEDULED

BASE, AS SCHEDULED ---

BATT. INSUL.

5/8" GYP. BD. EACH SIE OF 3 5/8" MTL. STUDS

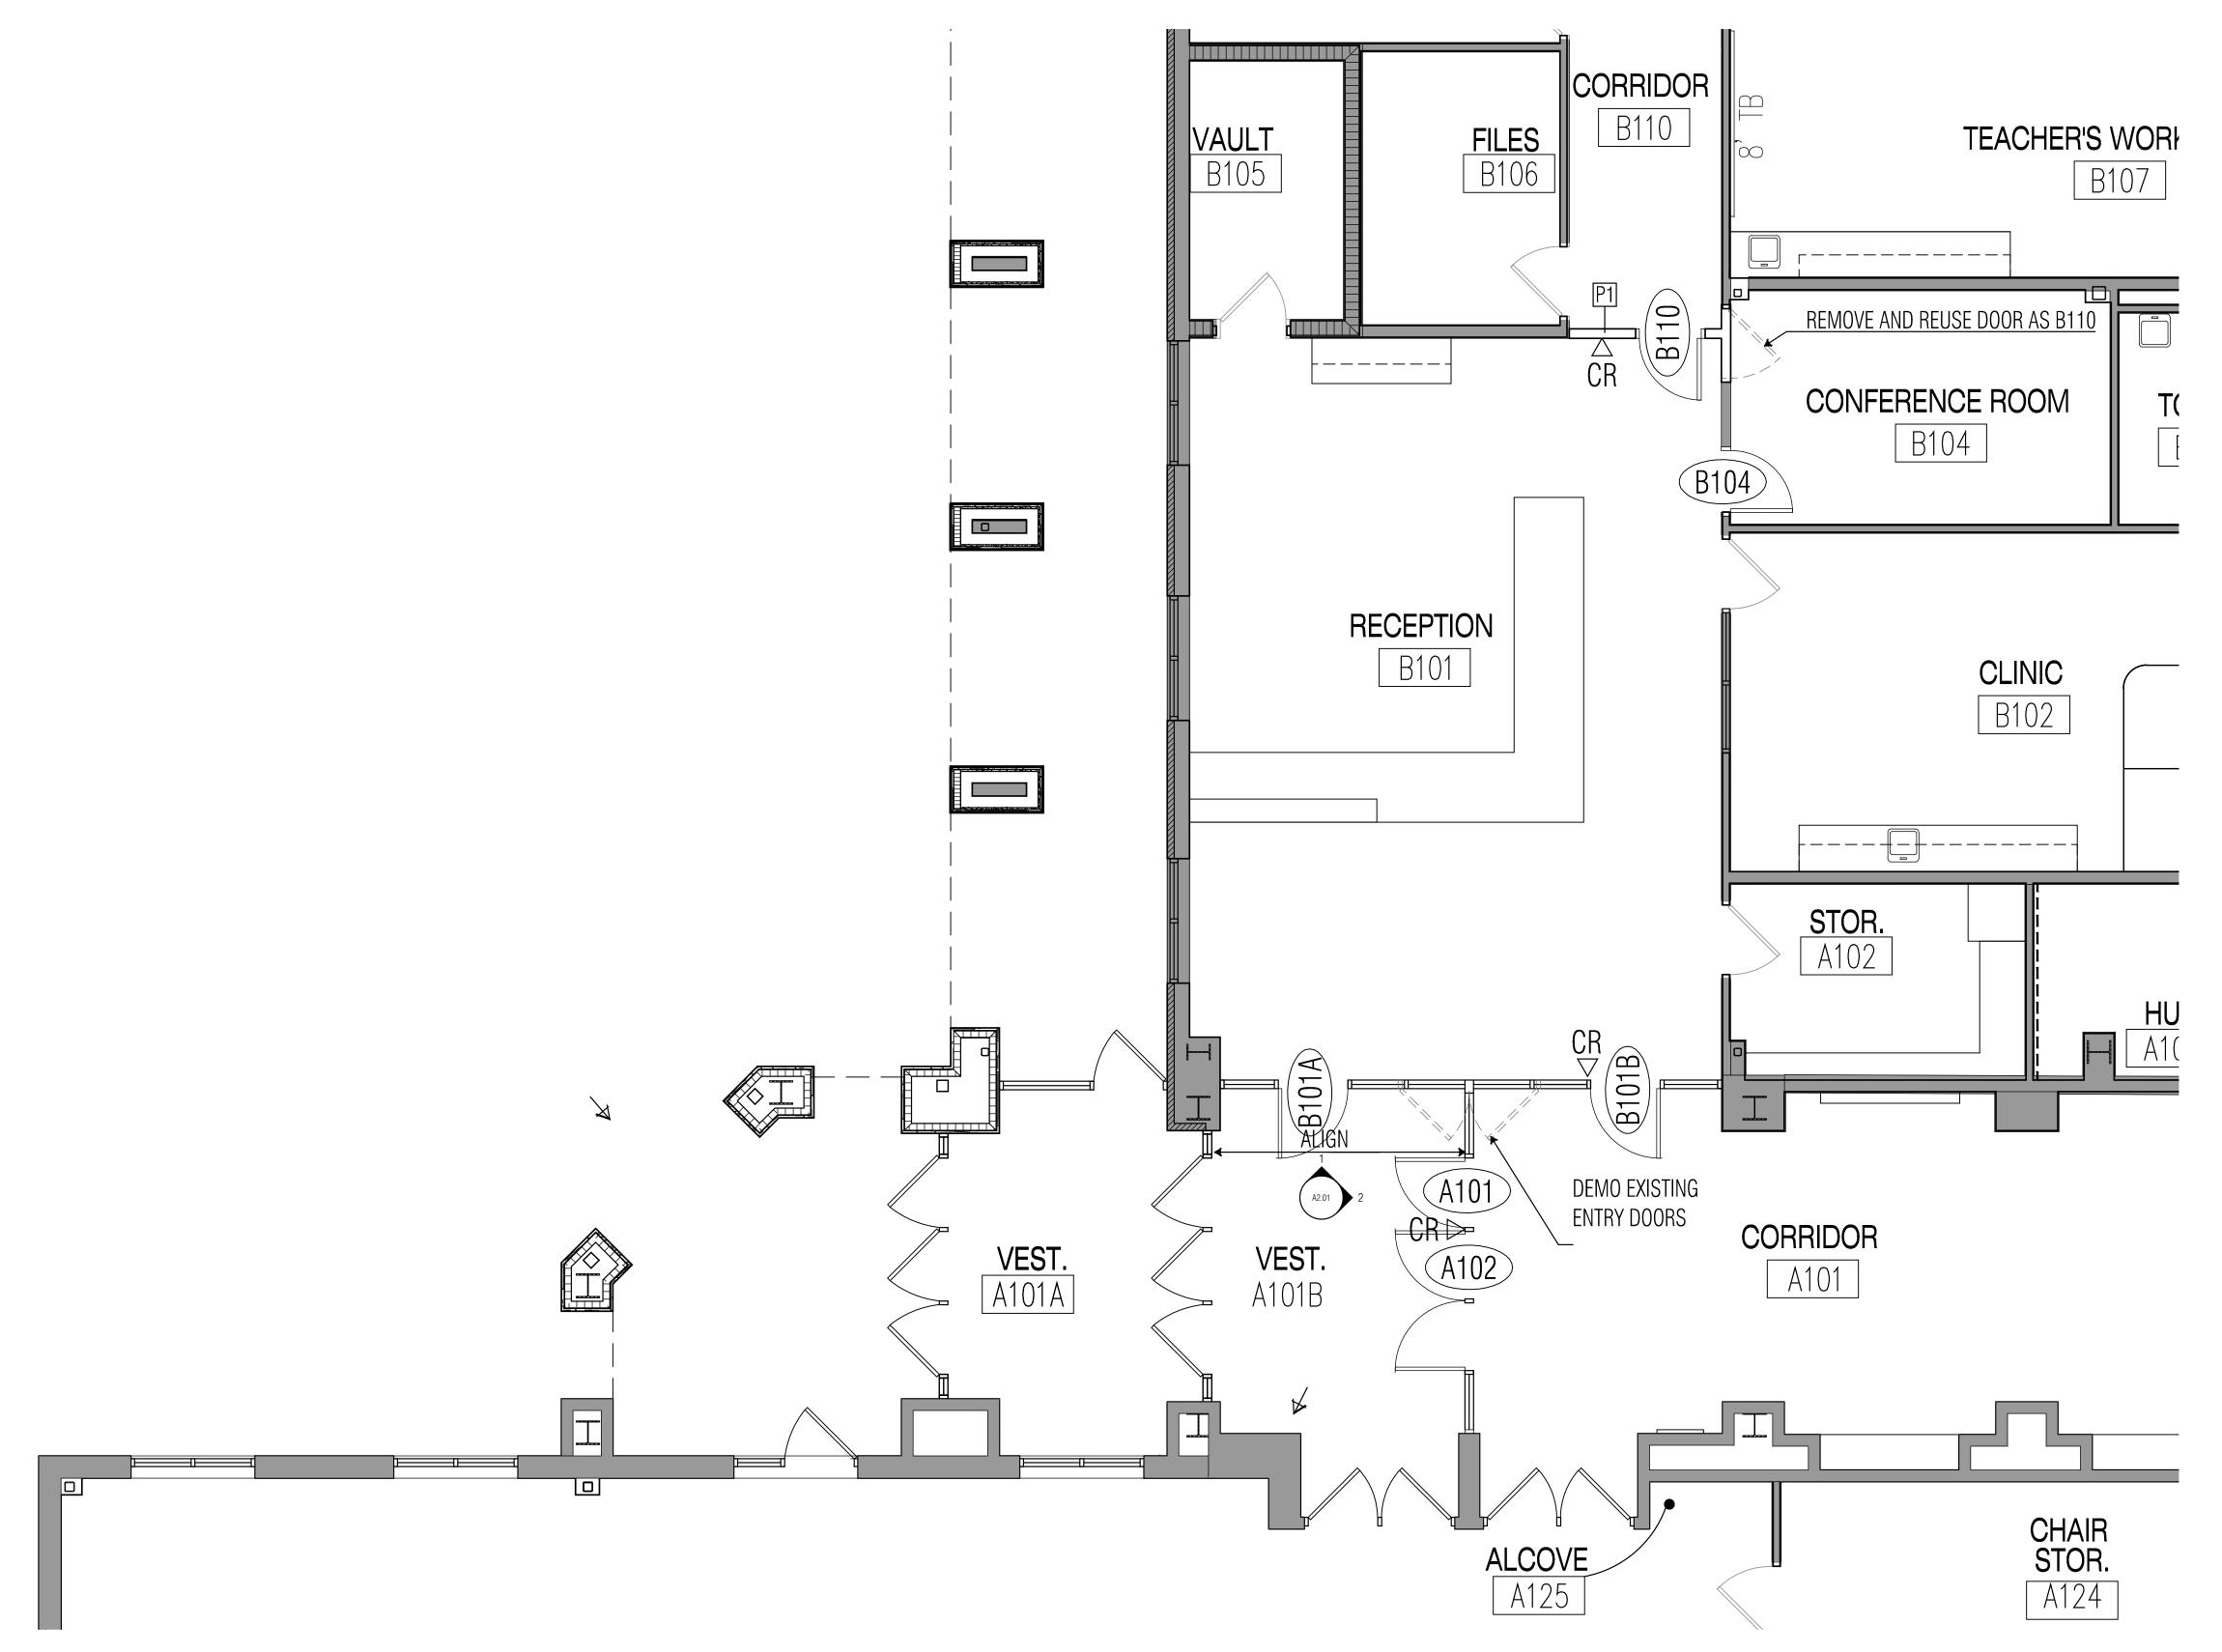

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SHEET TITLE

FLOOR PLAN **ELEVATIONS** HIGH COUNTRY

SHEET NO.

VLK Architects, Inc.

--- C701A ACCESS CONTROL HARDWARE

--- C701A ACCESS CONTROL HARDWARE

--- C701 ACCESS CONTROL HARDWARE

* HARDWARE TO MEET TDLR REQUIREMENTS

GLASS TYPE LEGEND CT TEMPERED INSULATING GLASS 1" THICK, CLEAR

CT4 TEMPERED INSULATING GLASS 1/4" THICK, CLEAR

DOOR SCHEDULE

A102

PORTION OF EXISTING GLAZING AND FRAMING

TO REMAIN

1 STOREFRONT ELEVATION

SCALE: 1/4" = 1'-0"

2 STOREFRONT ELEVATION

SCALE: 1/4" = 1'-0"

FLOOR PLAN- REMINGTON POINT ES

SCALE: 1/4" = 1'-0"

A101

FACE OF EX FURRDOWN

COLD FORMED BOX HEADER.

BRACE TO EXISTING FRAMING
PROVIDE SLIP TRACK
FOR VERTICAL DEFLECTION

REMOVABLE MULLION

3 PARTITION TYPE


SCALE: 1 1/2" = 1'-0"

FINISH, AS SCHEDULED

BASE, AS SCHEDULED ---

BATT. INSUL.

5/8" GYP. BD. EACH SIE OF 3 5/8" MTL. STUDS

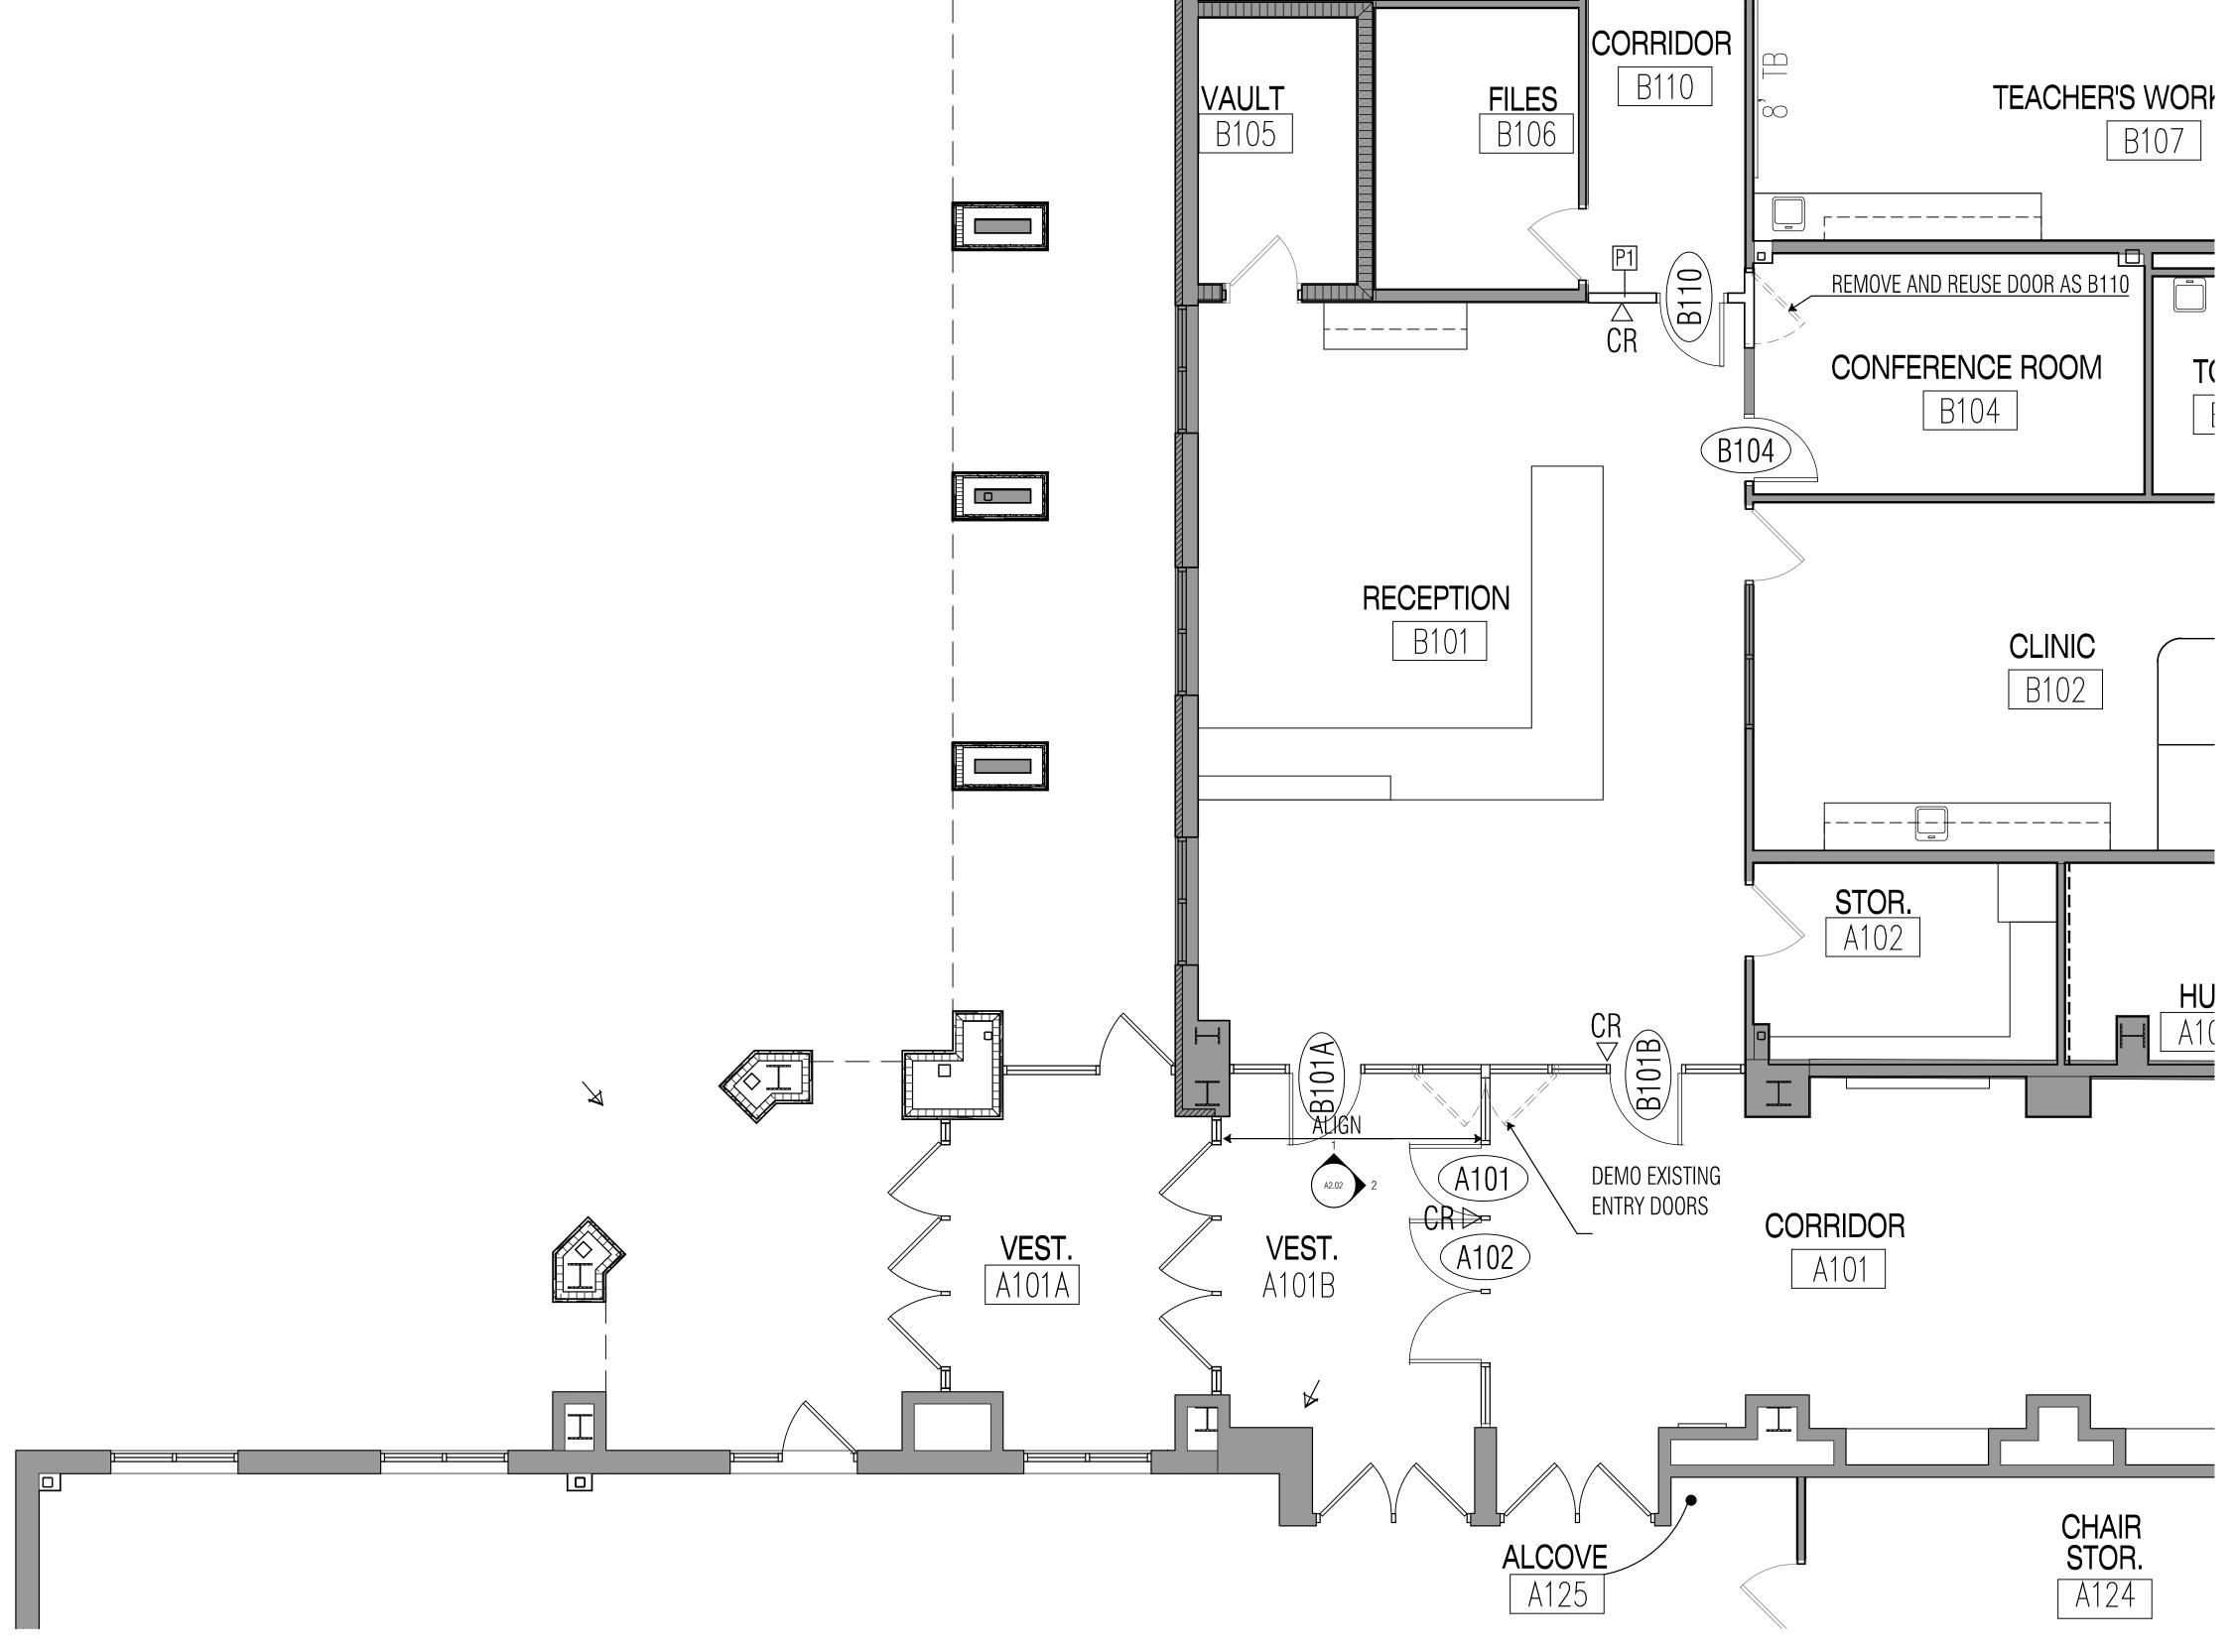

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FLOOR PLAN **ELEVATIONS** REMINGTON POINT SHEET NO.

PROJECT NO.

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* HARDWARE TO MEET TDLR REQUIREMENTS

--- C701A ACCESS CONTROL HARDWARE

--- C701A ACCESS CONTROL HARDWARE

--- C701 ACCESS CONTROL HARDWARE

GLASS TYPE LEGEND CT TEMPERED INSULATING GLASS 1" THICK, CLEAR

CT4 TEMPERED INSULATING GLASS 1/4" THICK, CLEAR

DOOR SCHEDULE

3 PARTITION TYPE

SCALE: 1 1/2" = 1'-0"

FINISH, AS SCHEDULED

BATT. INSUL.

BASE, AS SCHEDULED

5/8" GYP. BD. EACH SIE OF 3 5/8" MTL. STUDS

1 STOREFRONT ELEVATION

EXISTING STOREFRONT FRAMING AND GLASS TO REMAIN

2" 1 3/4" 1 3/4" 1 3/4" 4 1/2" 1 3/4" 1 3/4" 1 3/4" 1 3/4" (2'-4 3/4" 3'-0" 1'-10" 2'-9 3/4" 1 2'-5"

2 STOREFRONT ELEVATION

SCALE: 1/4" = 1'-0"

EXISTING STOREFRONT FRAMING AND GLASS


TO REMAIN

FACE OF EX FURRDOWN

COLD FORMED BOX HEADER.
BRACE TO EXISTING FRAMING

PROVIDE SLIP TRACK
FOR VERTICAL DEFLECTION

REMOVABLE MULLION

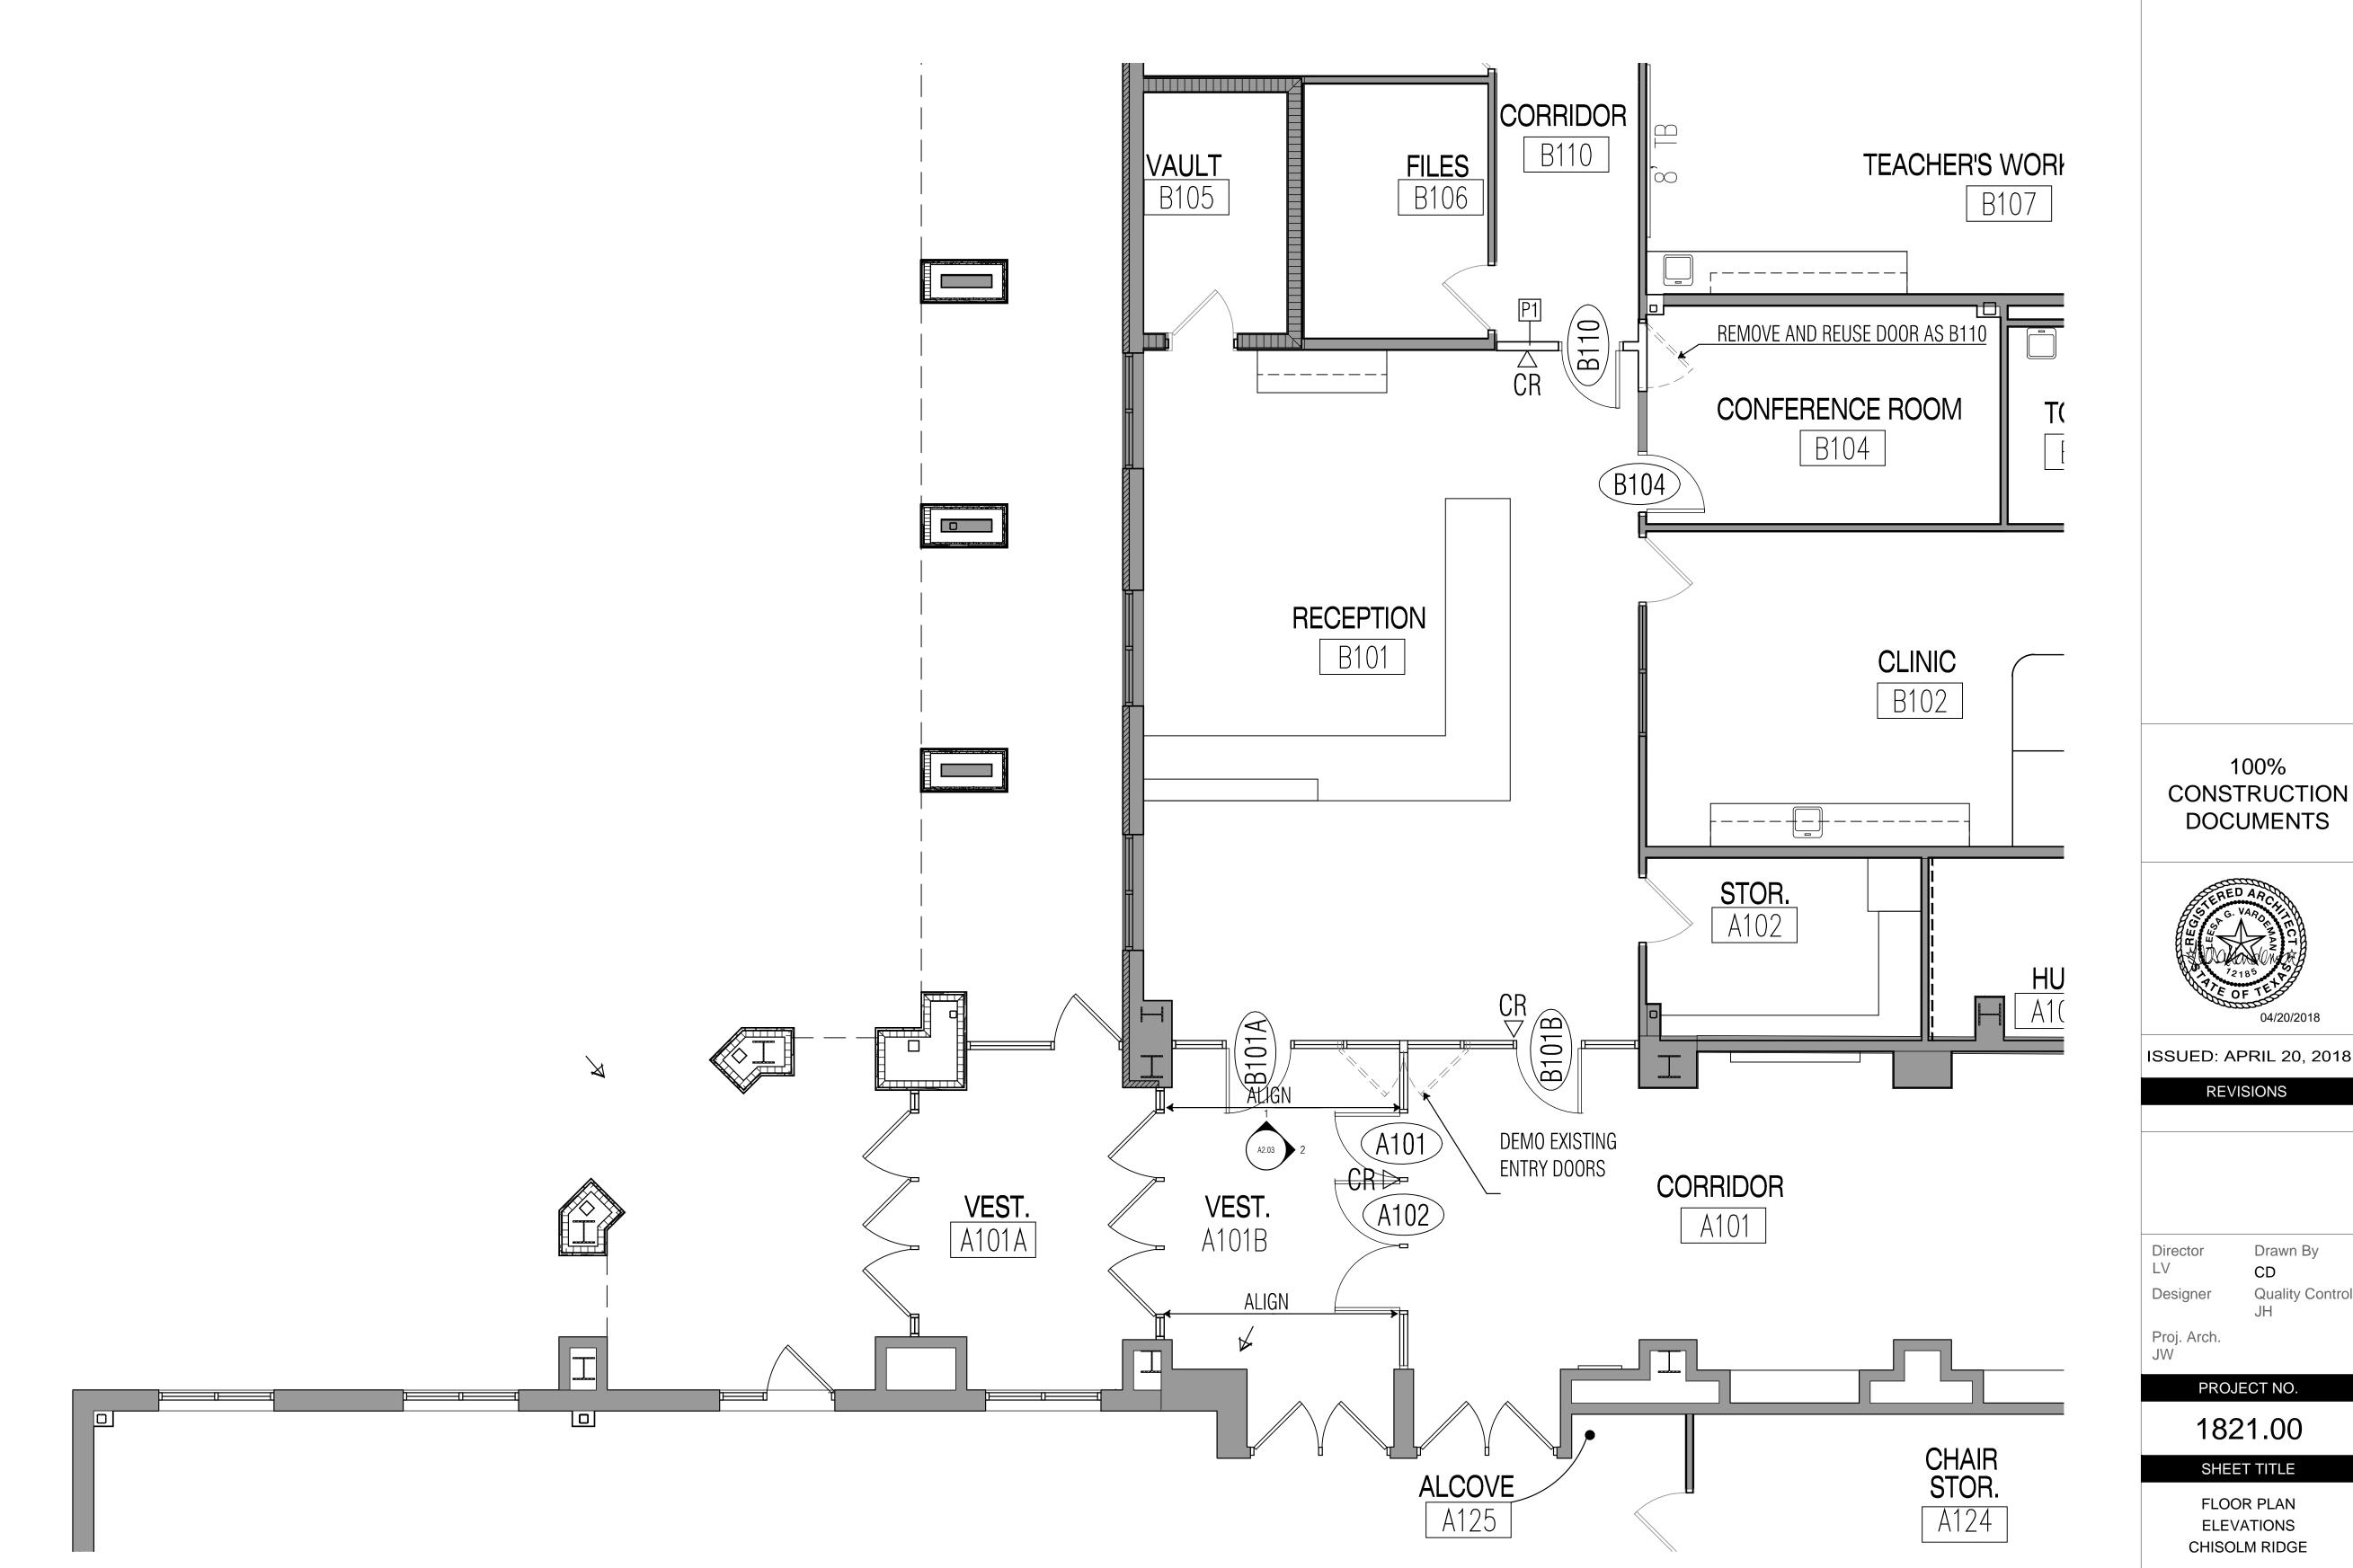

FLOOR PLAN- CHISOLM RIDGE

Proj. Arch. JW PROJECT NO. 1821.00

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SHEET TITLE FLOOR PLAN **ELEVATIONS**

CHISOLM RIDGE SHEET NO.

GLASS TYPE LEGEND

--- C701A ACCESS CONTROL HARDWARE

--- C701A ACCESS CONTROL HARDWARE

--- C701 ACCESS CONTROL HARDWARE

* HARDWARE TO MEET TDLR REQUIREMENTS

CT TEMPERED INSULATING GLASS 1" THICK, CLEAR CT4 TEMPERED INSULATING GLASS 1/4" THICK, CLEAR

DOOR SCHEDULE

3 PARTITION TYPE

SCALE: 1 1/2" = 1'-0"

FINISH, AS SCHEDULED

BATT. INSUL.

BASE, AS SCHEDULED

5/8" GYP. BD. EACH SIE OF 3 5/8" MTL. STUDS

1 STOREFRONT ELEVATION

EXISTING STOREFRONT FRAMING AND GLASS TO REMAIN

2" 1 3/4" 1 3/4" 1 3/4" 4 1/2" 1 3/4" 1 3/4" 1 3/4" 1 3/4" (2'-4 3/4" 3'-0" 1'-10" 2'-9 3/4" 1 2'-5"

2 STOREFRONT ELEVATION

SCALE: 1/4" = 1'-0"

EXISTING STOREFRONT FRAMING AND GLASS

TO REMAIN

FACE OF EX FURRDOWN


COLD FORMED BOX HEADER.
BRACE TO EXISTING FRAMING

PROVIDE SLIP TRACK
FOR VERTICAL DEFLECTION


REMOVABLE MULLION

FLOOR PLAN- GREENFIELD ES

SCALE: 1/4" = 1'-0"

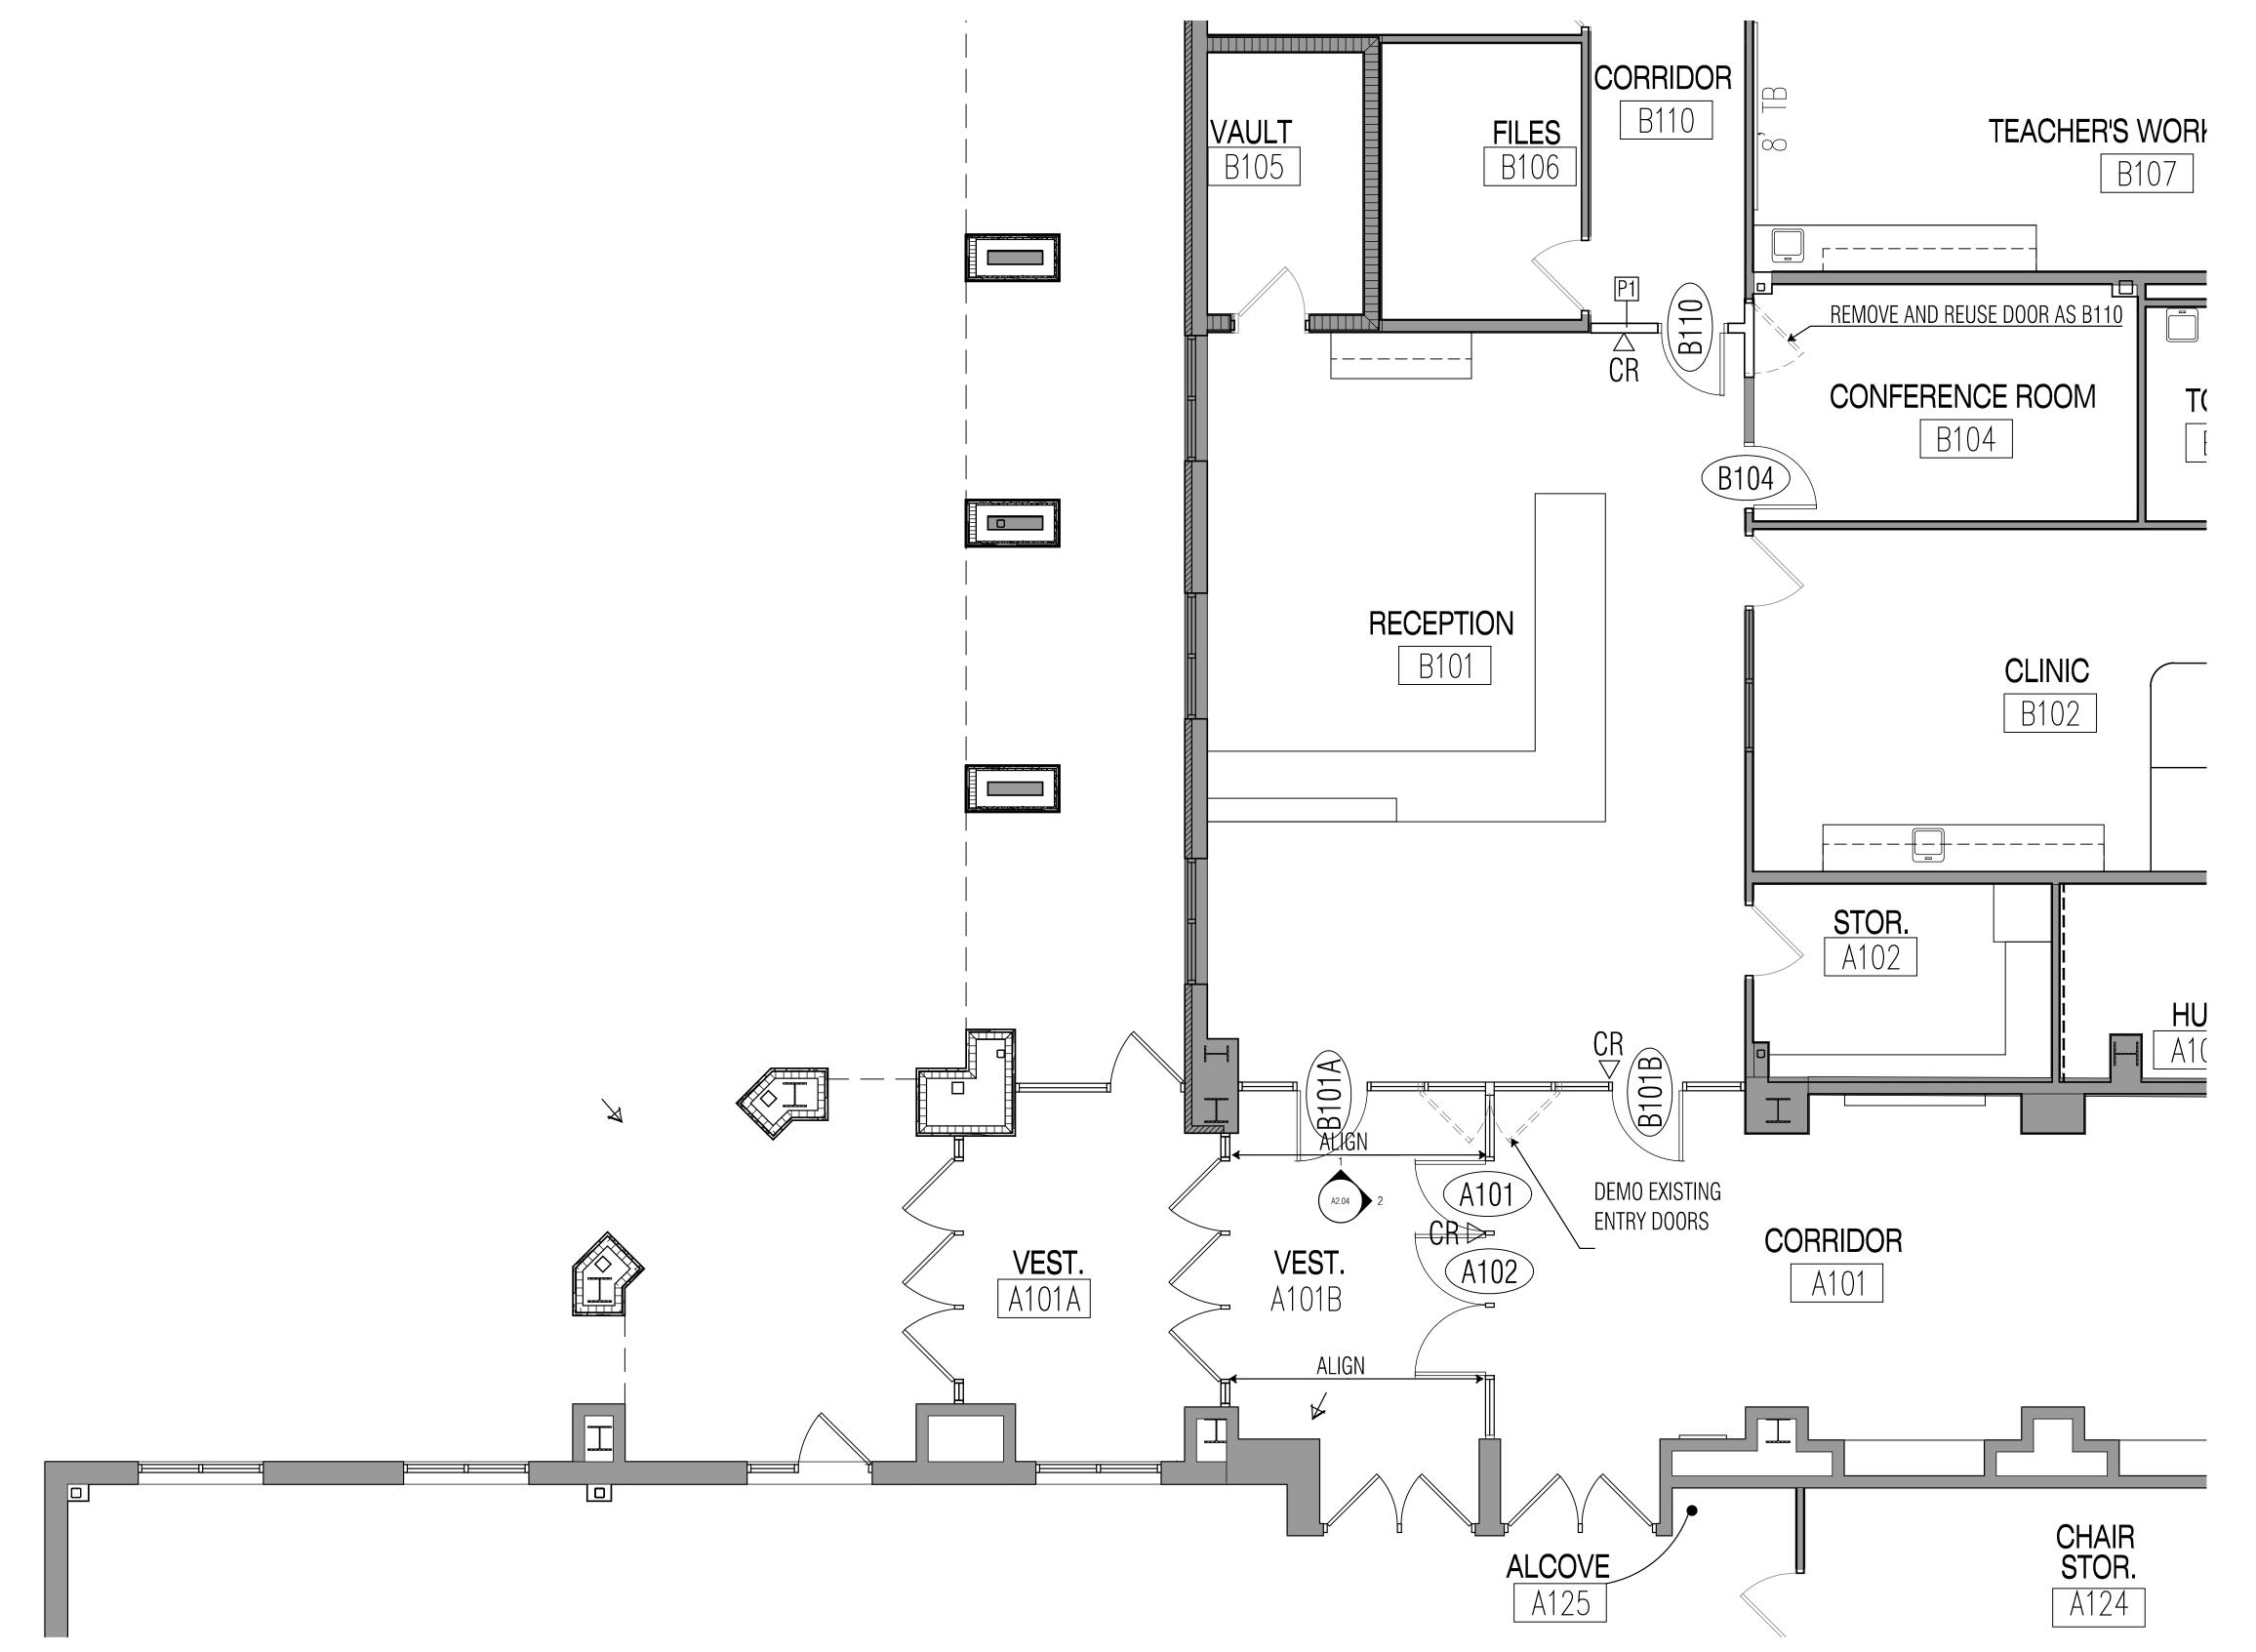

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SHEET TITLE FLOOR PLAN

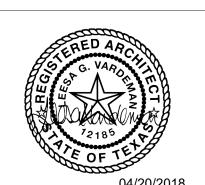ELEVATIONS GREENFIELD SHEET NO.



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PROJECT NO.

1821.00 SHEET TITLE

FLOOR PLAN ELEVATIONS COMANCHE SPRINGS


SHEET NO.

A2.05




1 STOREFRONT ELEVATION

SCALE: 1/4" = 1'-0"

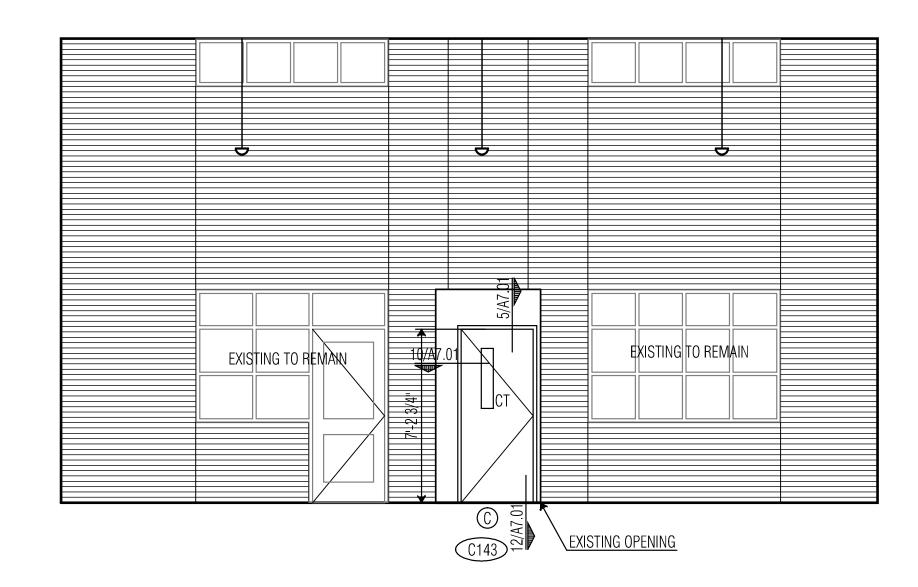

REMOVABLE MULLION

2 STOREFRONT ELEVATION
SCALE: 1/4" = 1'-0"

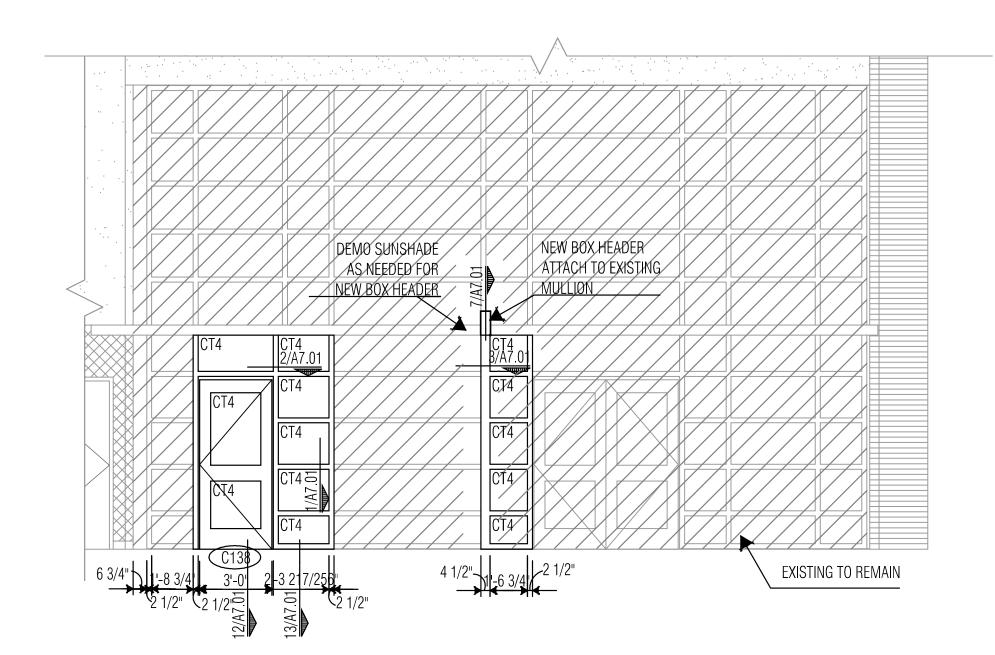

3 STOREFRONT ELEVATION

SCALE: 1/4" = 1'-0"



DOOR SCHEDULE


GLASS TYPE LEGEND

ACCESS CONTROL HARDWARE

* HARDWARE TO MEET TDLR REQUIREMENTS

5/8" GYP. BD. EACH SIDE OF 3 5/8" MTL. STUDS

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ISSUED: APRIL 20, 2018

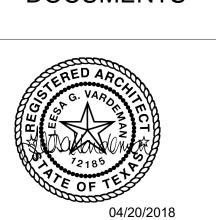PROJECT NO.

1821.00

SHEET TITLE FLOOR PLAN **ELEVATIONS**

NORTHBROOK SHEET NO.

A2.06

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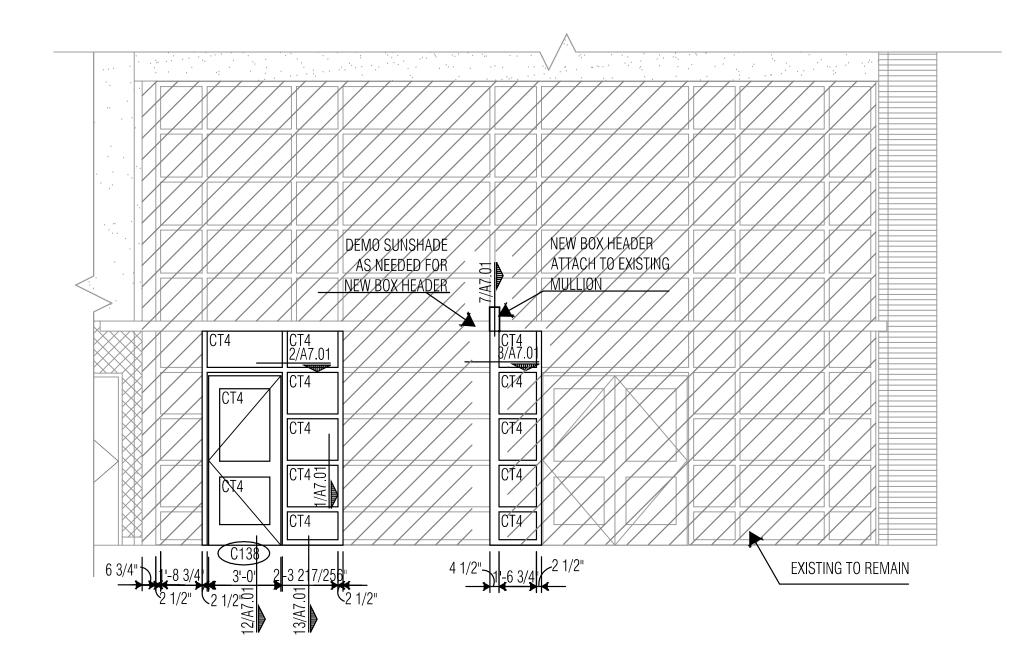


—REMOVABLE MULLION

2 STOREFRONT ELEVATION
SCALE: 1/4" = 1'-0"

1 STOREFRONT ELEVATION


SCALE: 1/4" = 1'-0"



3 STOREFRONT ELEVATION

SCALE: 1/4" = 1'-0"



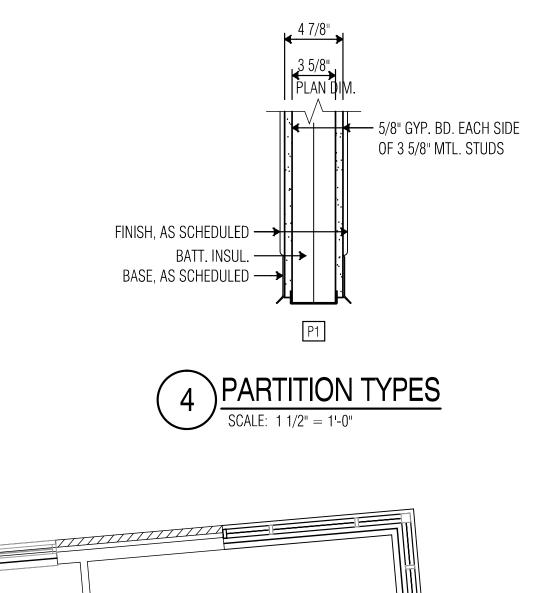

DOOR SCHEDULE

GLASS TYPE LEGEND

ACCESS CONTROL HARDWARE * HARDWARE TO MEET TDLR REQUIREMENTS



ISSUED: APRIL 20, 2018

PROJECT NO.


1821.00

SHEET TITLE FLOOR PLAN **ELEVATIONS**

LAKEPOINT SHEET NO.


A2.07

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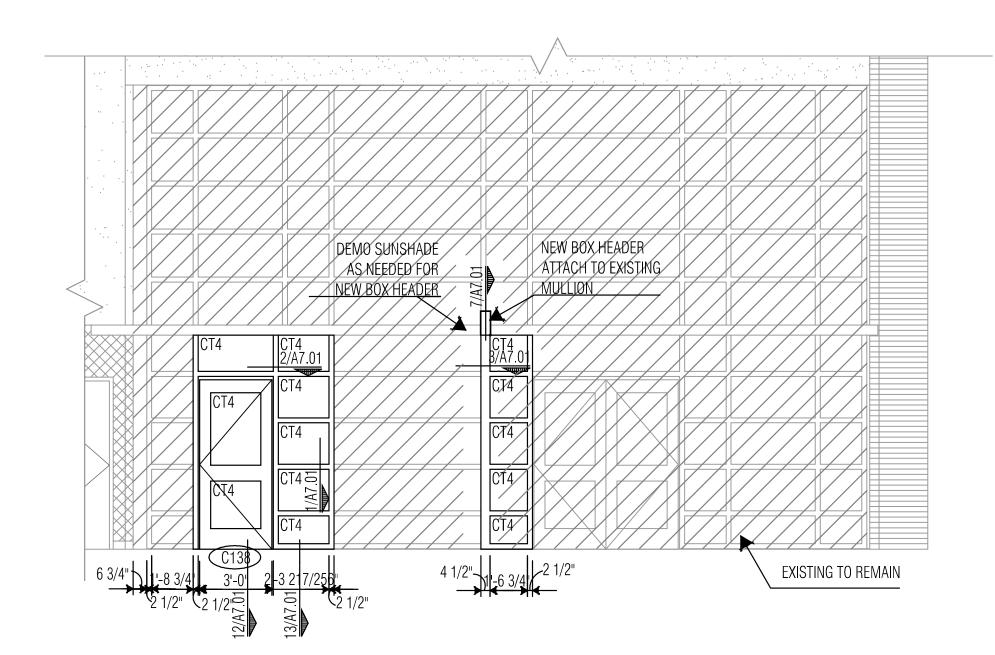


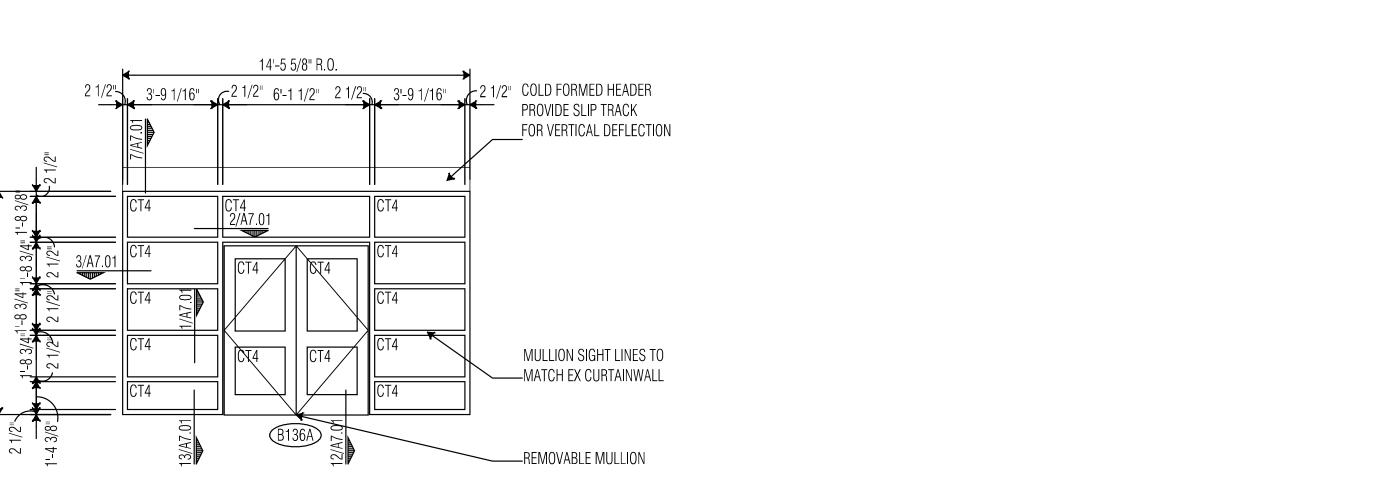1 STOREFRONT ELEVATION

SCALE: 1/4" = 1'-0"

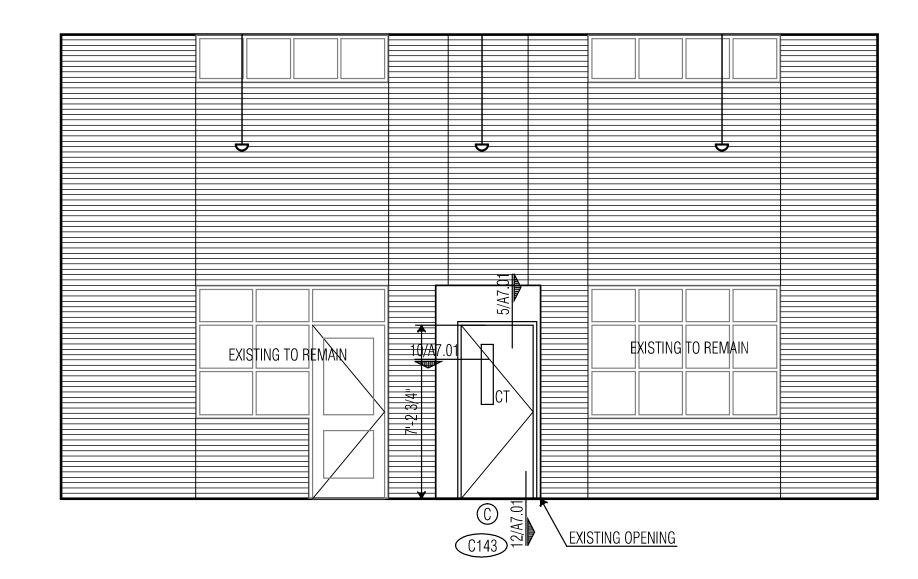


2 STOREFRONT ELEVATION
SCALE: 1/4" = 1'-0"



3 STOREFRONT ELEVATION

SCALE: 1/4" = 1'-0"

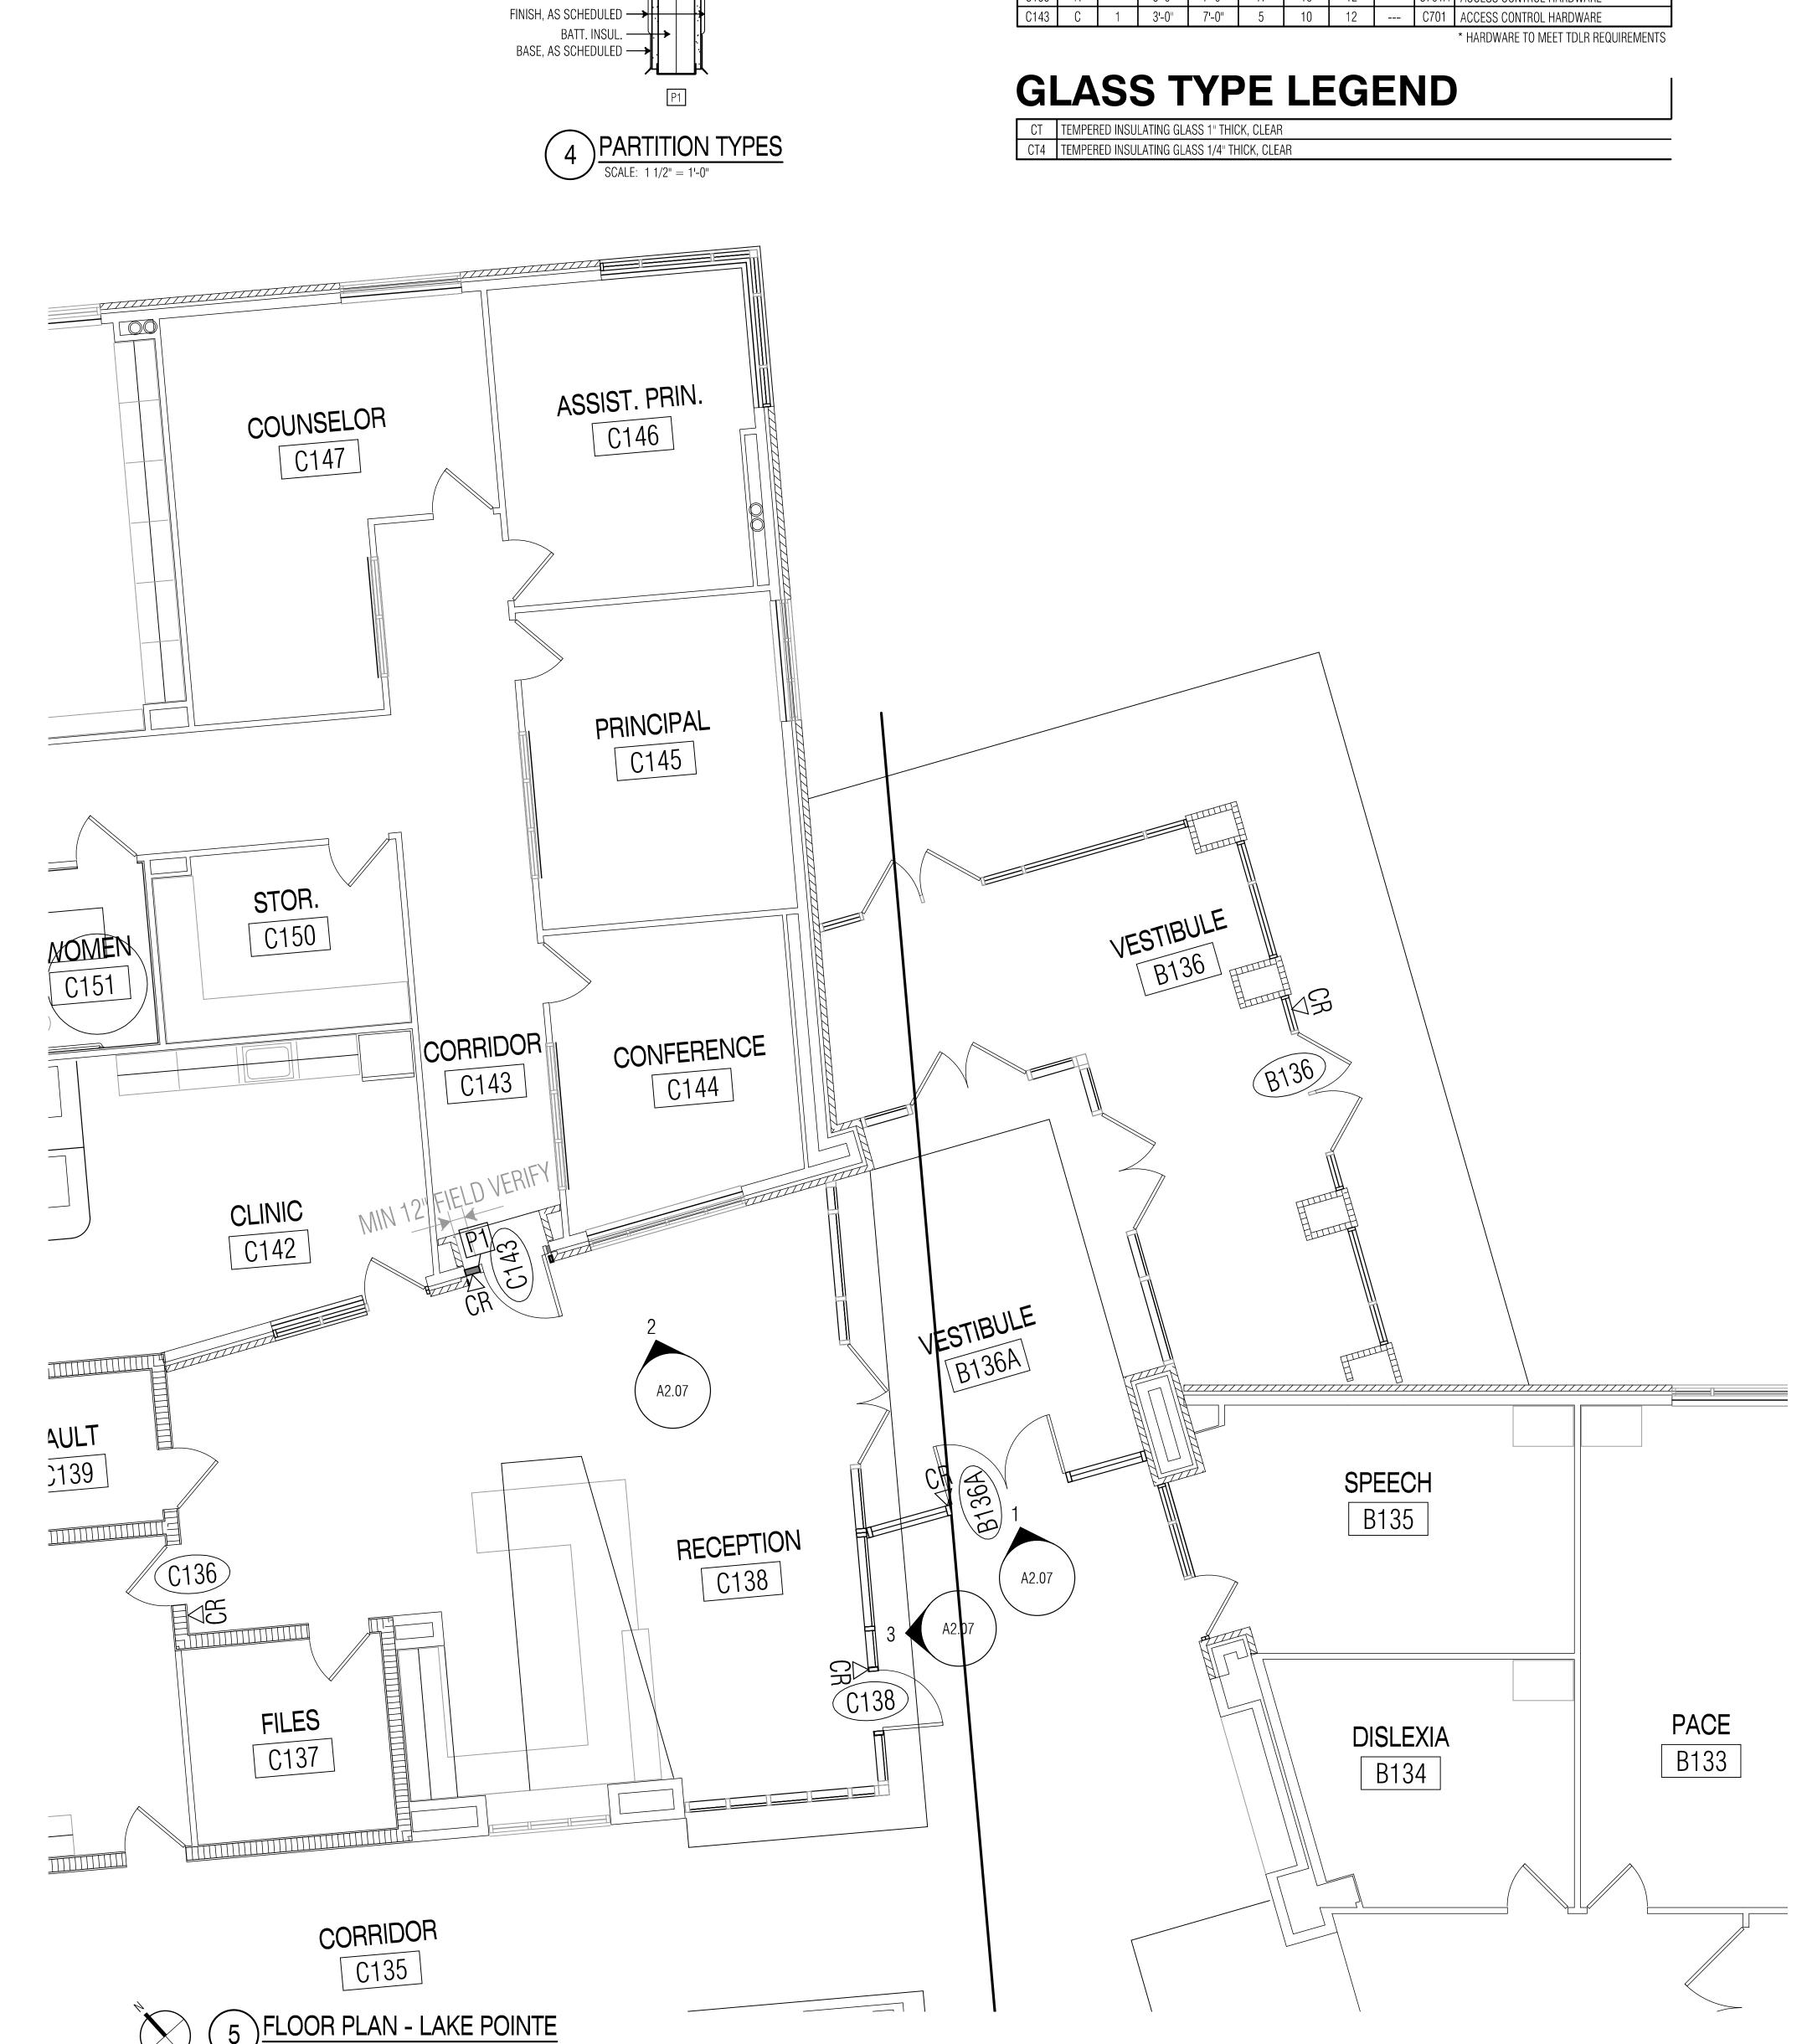

5/8" GYP. BD. EACH SIDE OF 3 5/8" MTL. STUDS

DOOR SCHEDULE

ACCESS CONTROL HARDWARE

CONSTRUCTION DOCUMENTS



ISSUED: APRIL 20, 2018 **REVISIONS**

Drawn By

Director Proj. Arch. JW

PROJECT NO.


1821.00

SHEET TITLE FLOOR PLAN **ELEVATIONS**

PARKVIEW SHEET NO.

A2.08

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2 1/2" 3'-9 1/16" (2 1/2" 6'-1 1/2" 2 1/2", 3'-9 1/16")

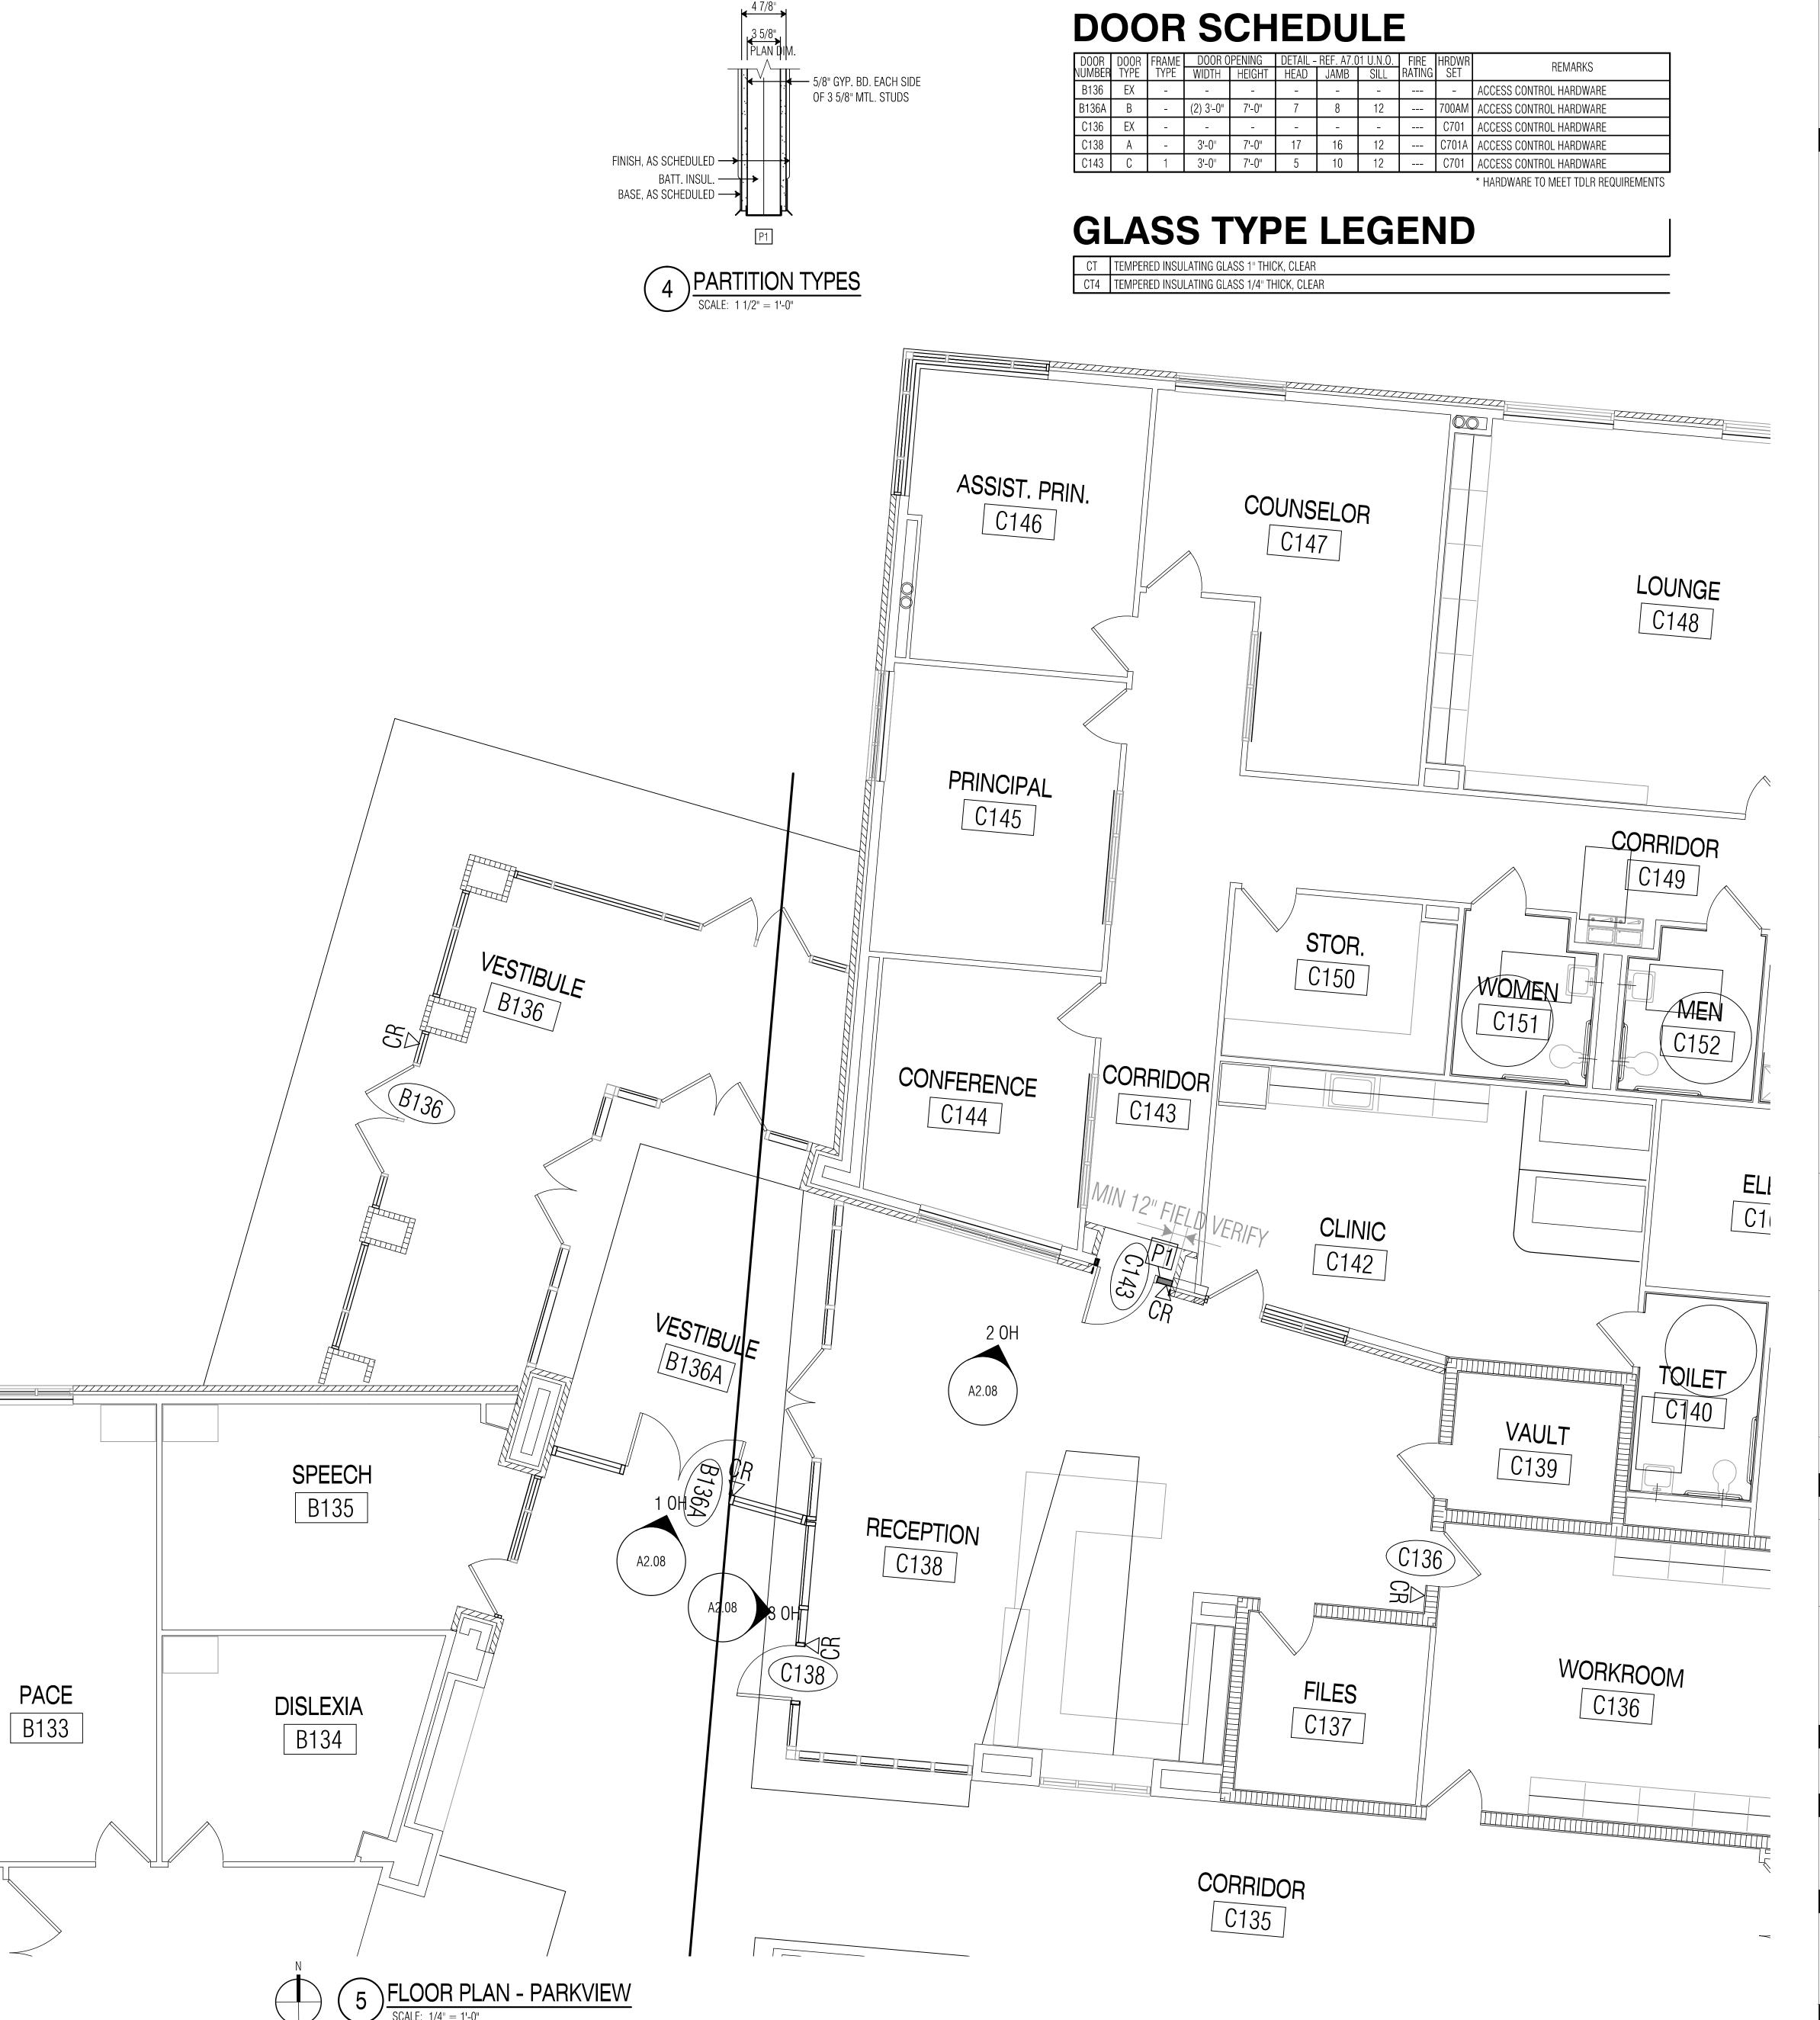
2 1/2" COLD FORMED HEADER

PROVIDE SLIP TRACK FOR VERTICAL DEFLECTION


MULLION SIGHT LINES TO

—MATCH EX CURTAINWALL

REMOVABLE MULLION

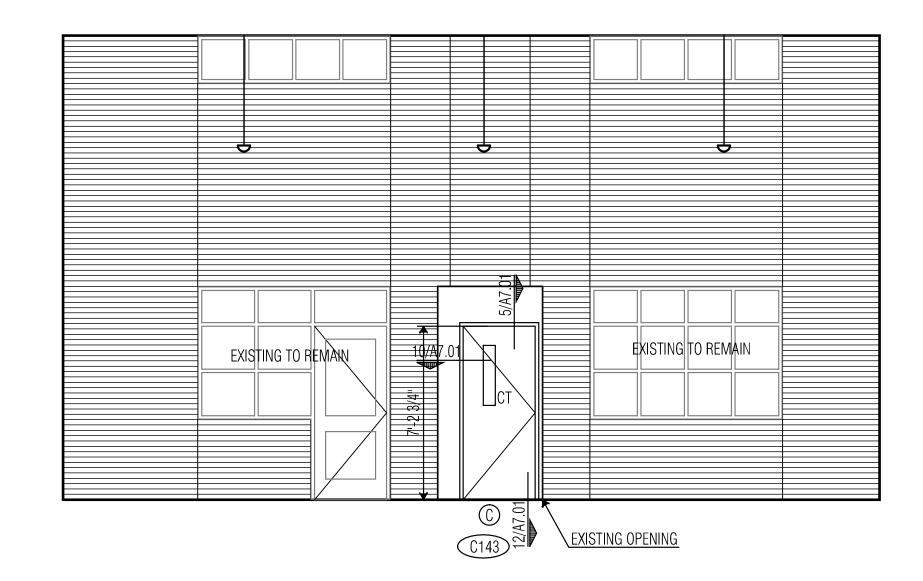


2 STOREFRONT ELEVATION
SCALE: 1/4" = 1'-0"

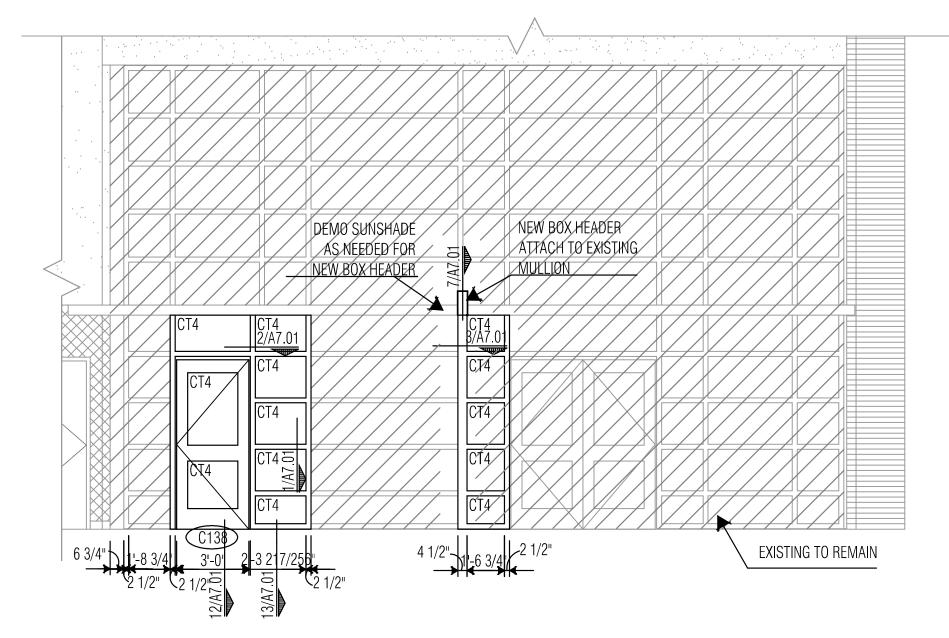

3 STOREFRONT ELEVATION

SCALE: 1/4" = 1'-0"

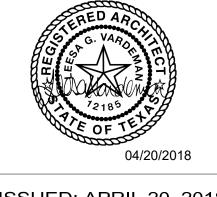

ISSUED: APRIL 20, 2018 REVISIONS

Drawn By

CD Designer Quality Contro Proj. Arch.


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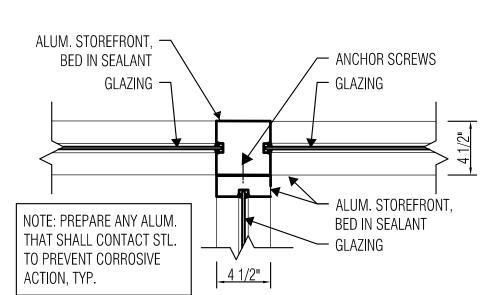
1821.00 SHEET TITLE


STOREFRONT DETAILS

SHEET NO.

A7.01




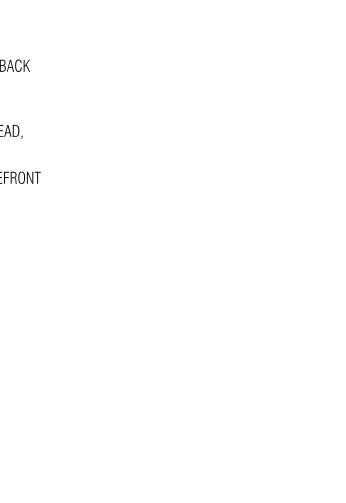


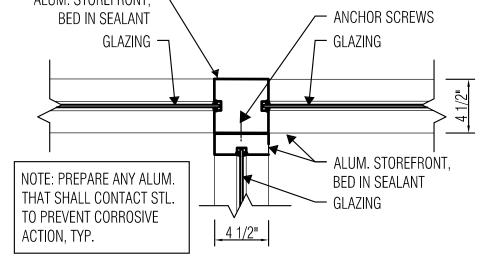


3 MULLION DETAIL

SCALE: 1 1/2" = 1'-0"

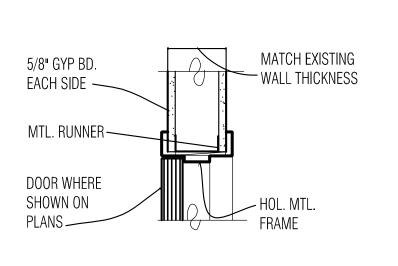

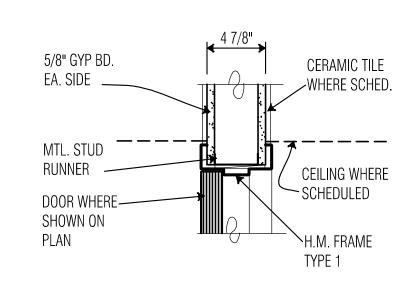


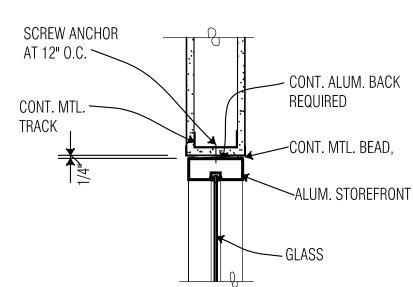










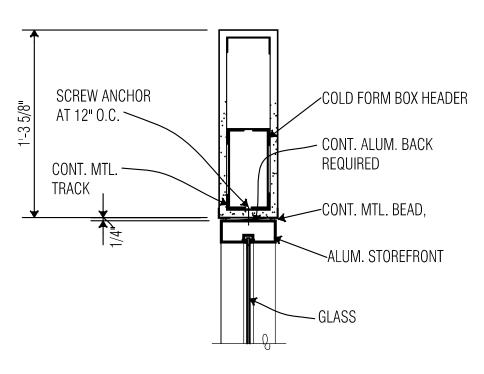



1 MULLION DETAIL

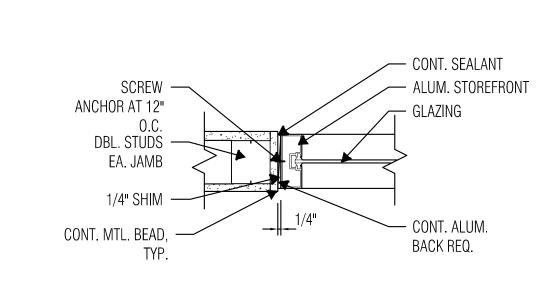

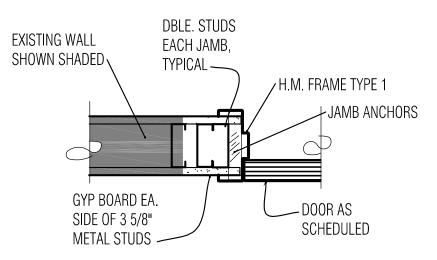


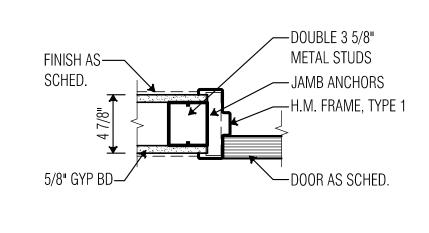

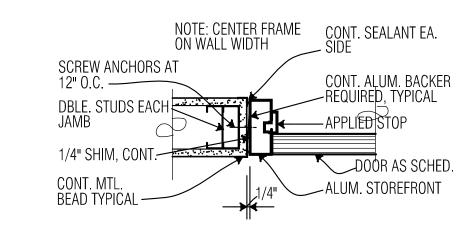

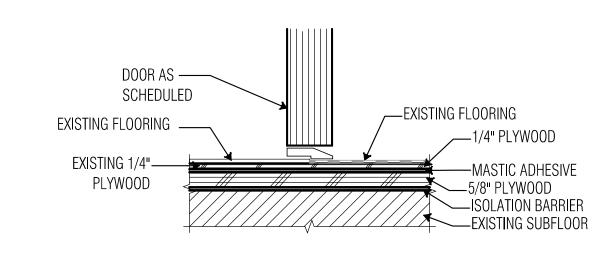



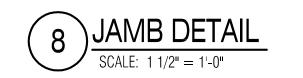


~ALUM. STOREFRONT









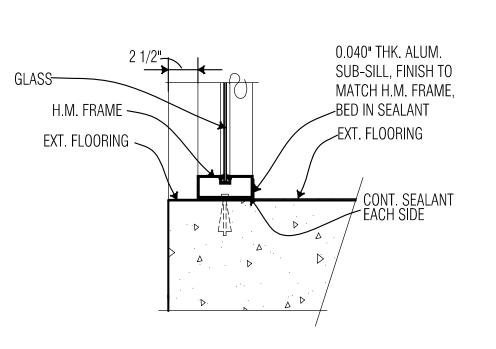




CONT. MTL. TRACK

ALUMINUM


STOREFRONT-

2 MULLION DETAIL


SCALE: 1 1/2" = 1'-0"

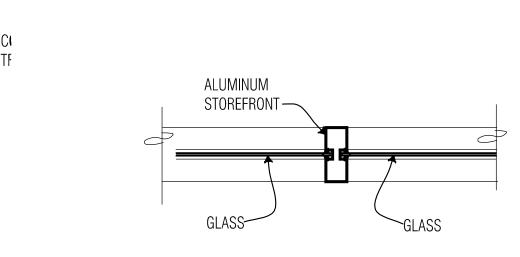



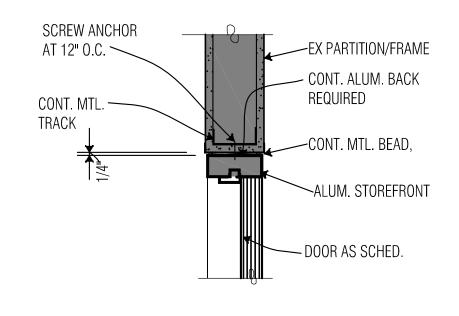



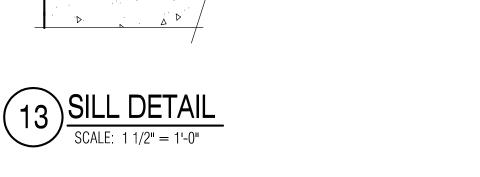

NOTE: CONTRACTOR SHALL CONFIRM COMPLIANCE OF EACH

TO NOTIFYING THE ARCHITECT, THE CONTRACTOR SHALL

MODIFY THE DOOR LOCATION OR ADJACENT ITEMS AS NECESSARY TO ACHIEVE THE REQUIRED CLEARANCE WITH

NOTE:
REF. FLOOR PLAN FOR PARTITION TYPES. THIS DETAIL
APPLIES TO ALL NEW DOORS AND ALL EXISTING DOORS

TO REMAIN WITHIN THE AREAS CONTAINING WORK AS

DEFINED BY THE CONSTRUCTION DOCUMENTS.

NO ADDITIONAL COST TO OWNER.





WALL LOCATIONS)

BED (BOTH SIDES)


----- CRIPPLE STUD, 1/2"

MIN. CLEARANCE

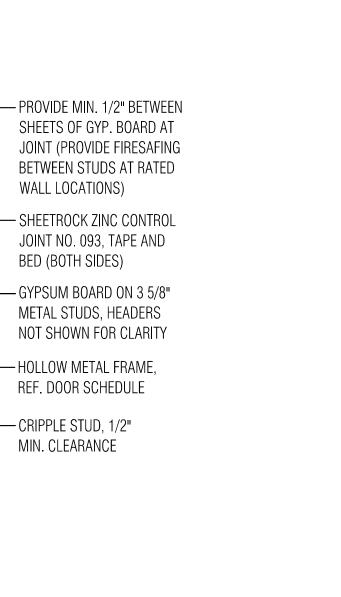


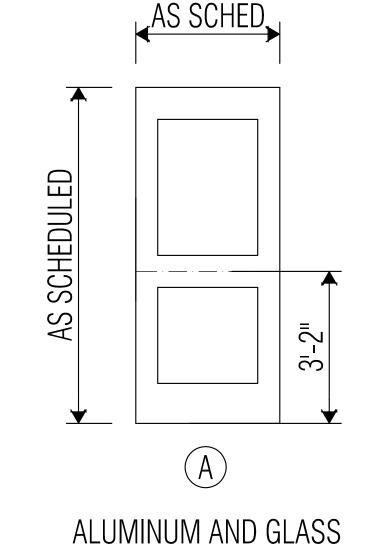




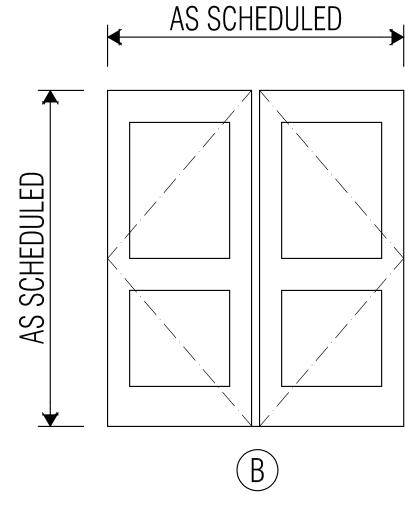

ALUMINUM AND GLASS DOOR BY STOREFRONT MFR, WIDE STILE DOOR FINISH IS TO MATCH EXISTING

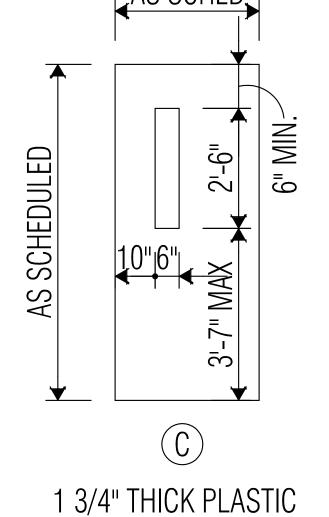

LAMINATE CLAD DOOR VISION PANEL LOCATED ON STRIKE SIDE FINISH IS TO MATCH EXISTING

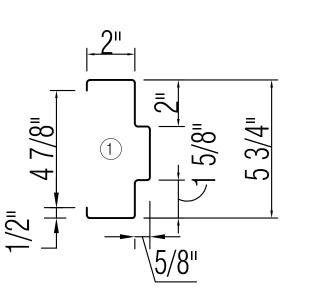



ANY OBSTRUCTION [

←APPLICABLE) ←

DOOR AS SCHEDULED —

